

General Notes:


- ALL WORK SHALL CONFORM TO THE LATEST FLORIDA BUILDING CODE, THE NFPA LIFE SAFETY CODE, AND ALL OTHER APPLICABLE CODES AND ORDINANCES. OBTAIN ALL REQUIRED PERMITS FOR THE PROPER LEGAL EXECUTION OF THE WORK DESCRIBED IN THESE DRAWINGS AND SPECIFICATIONS.
- PROVIDE A CONTINUOUS LOAD PATH FROM TRUSSES OR RAFTERS TO FOUNDATION FOR ALL NEW CONSTRUCTION. IF ANY DISCREPANCIES, CALL DESIGNER FOR CLARIFICATION BEFORE PROCEEDING.
- THE CONTRACTOR SHALL VERIFY ALL EXISTING CONDITIONS PRIOR TO STARTING ANY WORK. HE/SHE SHALL NOTIFY THE DESIGNER OF ANY DISCREPANCIES BETWEEN THE CONTRACT DOCUMENTS AND ACTUAL SITE CONDITIONS FOUND DURING OR PRIOR TO DEMOLITION.
- FOUNDATION DESIGN IS BASED ON 2000 PSF STABLE SOIL CONDITIONS.
- PROVIDE TESTING ON SOIL COMPACTION PRIOR TO LAYING STEEL OR POURING CONCRETE. COMPACTION SHOULD ACHIEVE 95% MODIFIED PROCTOR DENSITY.
- PROVIDE ADEQUATE BLOCKING BEHIND ALL WALL MOUNTED FIXTURES
- PROVIDE ALL ACCESSORIES, HARDWARE AND MISC. ITEMS AS PER DRAWINGS AND SPECIFICATIONS. ALL ITEMS SHALL BE INSTALLED AS PER MANUFACTURERS WRITTEN INSTRUCTIONS AND CUT SHEETS.
- CONTRACTOR MUST VERIFY ALL DIMENSIONS PRIOR TO CONSTRUCTION. DO NOT SCALE DRAWINGS.
- ALL CONCRETE SHALL BE 3000 PSI COMPRESSIVE STRENGTH AT 28 DAYS.
- INSTALL DOORS AND WINDOWS PER MANF. DATA PROVIDED W/ PRODUCT. CENTER UNLESS NOTED
- REFER TO WIND LOAD ANALYSIS FOR NAIL PATTERN AND SCHEDULE AND HOLD DOWN TABLES
- ATTIC OVER CONDITIONED SPACE IS UNVENTED. ATTIC INSULATION FOAM-IN-PLACE SPRAY FOAM
- 13. ATTIC OVER PORCHES IS VENTED. THE TOTAL NET FREE VENTILATING AREA SHALL NOT BE LESS THAN 1/150 OF THE AREA OF THE SPACE VENTILATED. VENTILATION OPENINGS HAVING A LEAST DIMENSION LARGER THAN 1/4 INCH (6.4 MM) SHALL BE PROVIDED WITH CORROSION-RESISTANT WIRE CLOTH SCREENING, HARDWARE CLOTH, OR SIMILAR MATERIAL WITH OPENINGS HAVING A LEAST DIMENSION OF 1/16 INCH (1.6 MM) MINIMUM AND 1/4 INCH (6.4 MM) MAXIMUM.
- 14. ALL FLASHING TO MEET CODES. FOLLOW MANUFACTURER'S DATA SHEET AND SMACNA STANDARDS.
- STRUCTURAL CONNECTORS LISTED ARE FOR EXAMPLE. OTHER PRODUCTS MAY BE SUBSTITUTED FOR ANY CONNECTORS LISTED PROVIDED THEY MEET THE REQUIRED LOAD CAPACITIES. FOLLOW MANUFACTURER'S INSTALLATION DATA. ANY CONNECTORS EXPOSED TO THE WEATHER SHALL BE HOT
- 16. ANCHOR BOLT MINIMUM EMBEDMENT IS 7" UNLESS OTHERWISE NOTED.
- 17. ELECTRICAL INFORMATION IS DIAGRAMMATIC ONLY.

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- ALL FIXTURES AND EQUIPMENT MUST MEET THE OWNER'S APPROVAL PRIOR TO PURCHASE AND
- ALL WOOD IN CONTACT WITH MASONRY OR CONCRETE SHALL BE PRESSURE TREATED. ALL STRUCTURAL WOOD EXPOSED TO WEATHER SHALL BE PRESSURE TREATED.
- 20. ALL WOOD AND WOOD CONSTRUCTION SHALL COMPLY WITH THE RELEVANT CODES AND SPECIFICATIONS AND THE 'AMERICAN INSTITUTE OF TIMBER CONSTRUCTION' (STANDARD MANUAL)
- 21. APPLICATION OF PAINT OR OTHER COATING SHALL BE IN STRICT ACCORDANCE WITH THE MANUFACTURER'S DIRECTIONS. READY-MIXED PAINT SHALL NOT BE THINNED, EXCEPT AS PERMITTED IN THE APPLICATION INSTRUCTIONS.
- ALL SURFACES TO BE FINISHED SHALL BE CLEAN AND FREE OF FOREIGN MATERIALS, (DIRT, GREASE, ASPHALT, RUST, ETC.)
- APPLICATION SHALL BE IN A WORKMANLIKE MANNER PROVIDING A SMOOTH SURFACE. APPLICATION RATE SHALL BE THAT RECOMMENDED BY THE MANUFACTURER. APPLICATION MAY BE BY BRUSH OR ROLLER, OR MAY BE BY SPRAY IF PAINT IS FORMULATED FOR SAME.
- PROVIDE EXTERIOR AND INTERIOR SURFACE FINISHES AS SCHEDULED, AS APPROPRIATE FOR THEIR LOCATION OR EXPOSURE TO WEATHER, AND AS RECOMMENDED BY THE MANUFACTURER.
- OTHER FINISHES AS PER CONSTRUCTION DOCUMENTS, FINISH SCHEDULE OR OWNER'S SPECIFICATIONS.
- THE DESIGNER SHALL NOT BE RESPONSIBLE FOR AND WILL NOT HAVE CONTROL OR CHARGE OF CONTRACTOR'S FAILURE TO CARRY OUT THE WORK IN ACCORDANCE WITH THE CONTRACT DOCUMENTS OMISSIONS OF THE CONTRACTOR, SUB-CONTRACTORS, OR ANY OF THEIR AGENTS OR EMPLOYEES, OR

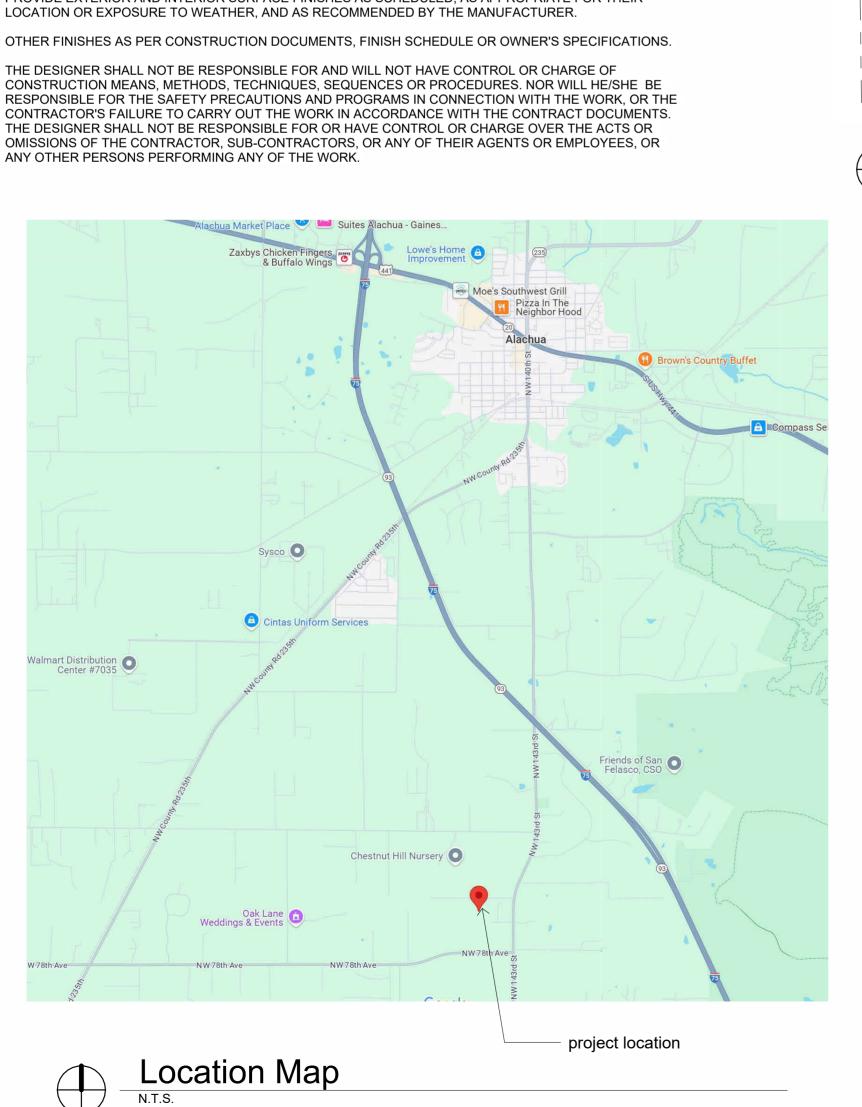

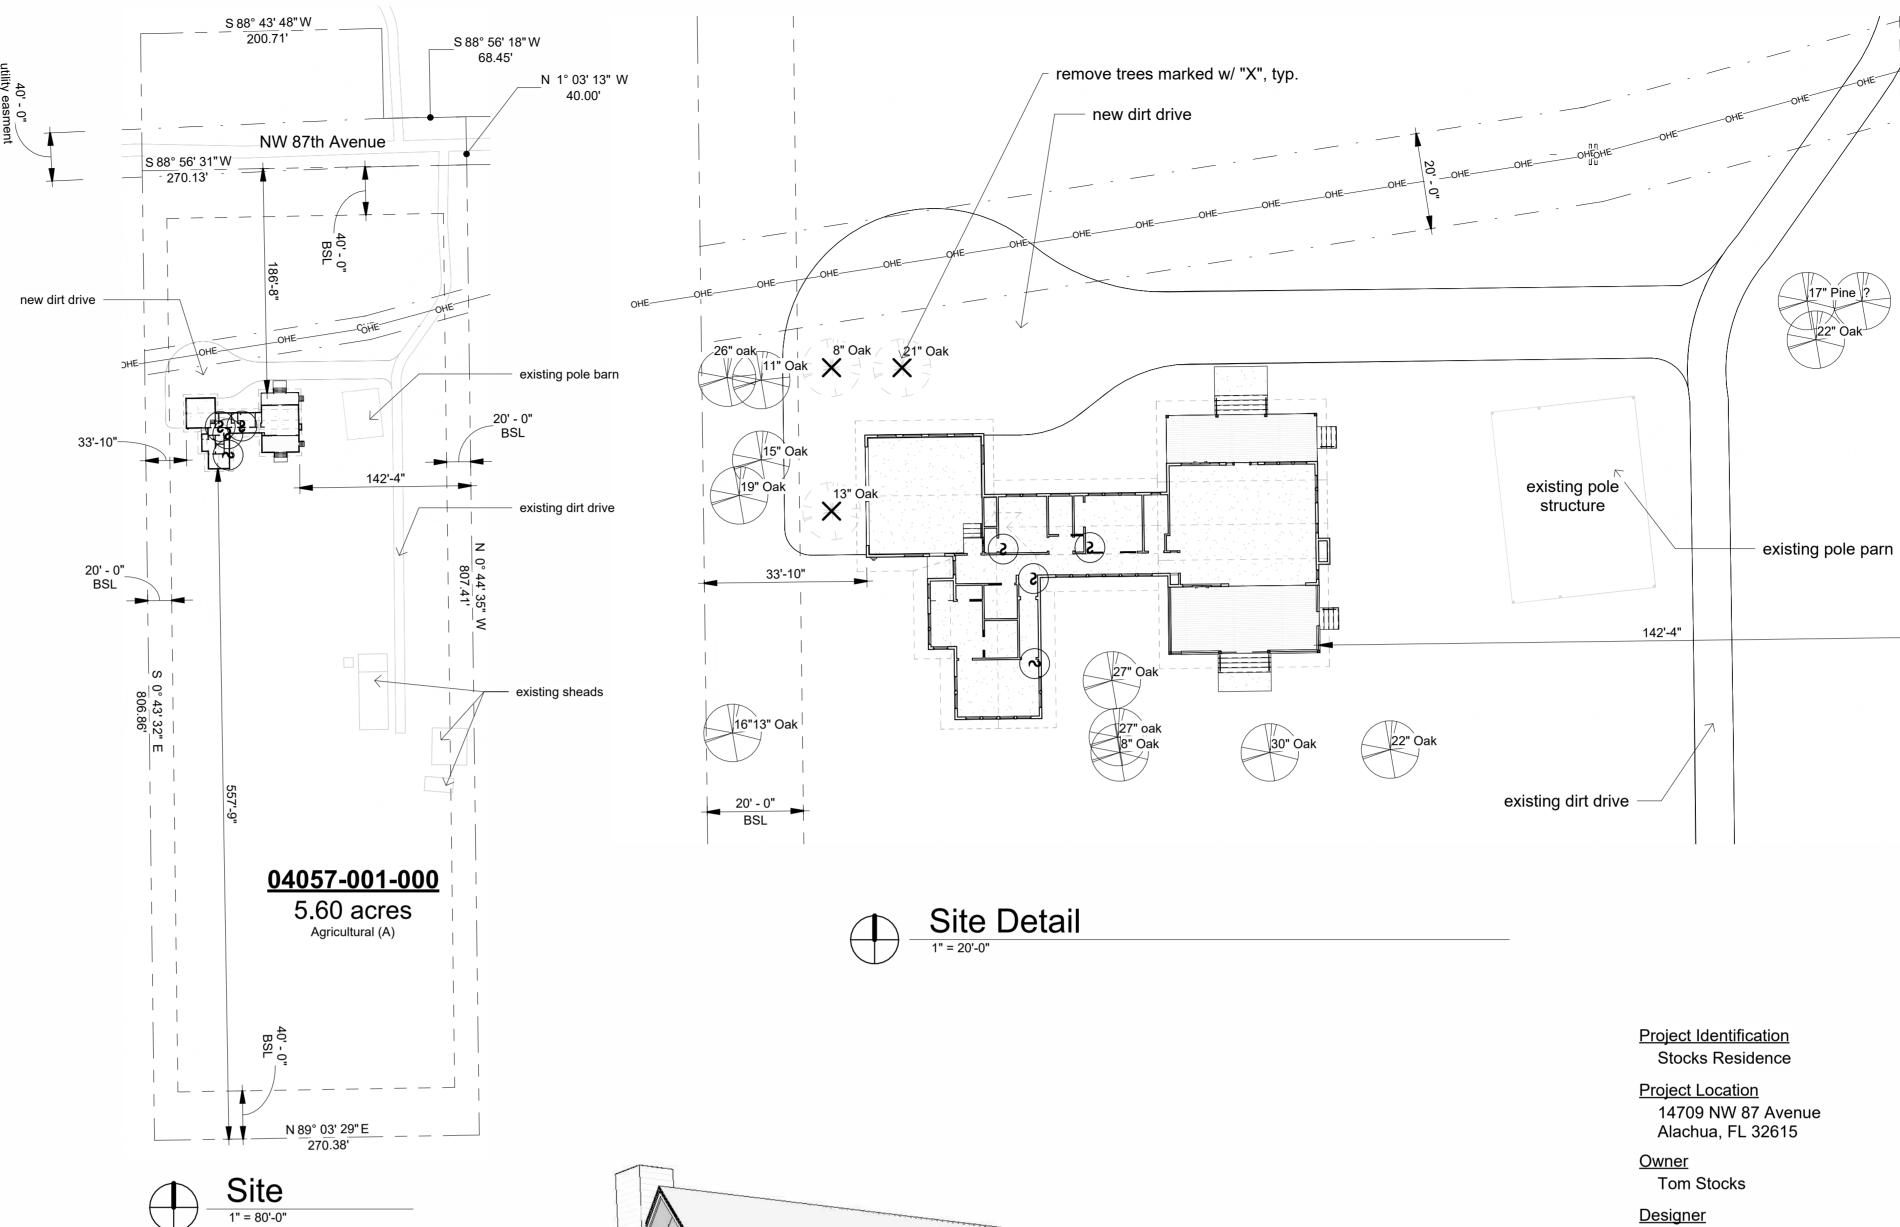



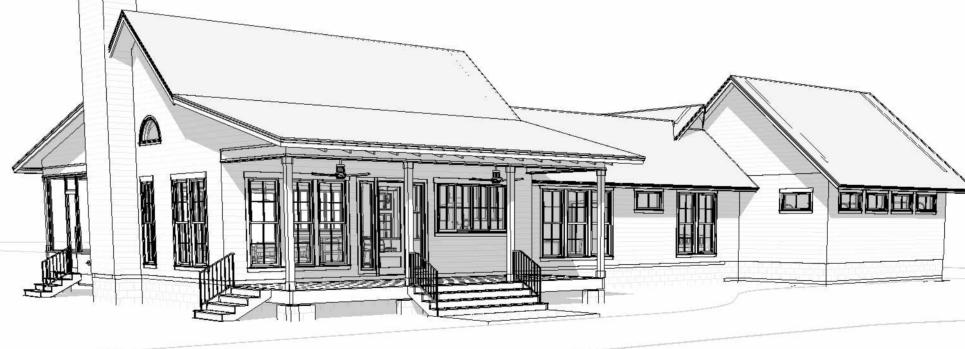Northeast View



Southwest View

Tom Stocks

<u>Designer</u>

Bob Harris - dba Bob Harris Design 2351 SW 56th Avenue Gainesville, Florida 32608

Building Code

All areas of construction shall comply with Florida Building Code 8th Addition 2023

Project Scope

New Home

3515 SF

Sheet List	
Sheet Number	Sheet Name
A0	Cover, Location, Notes
A1	Floor Plan
A2	Elevations
A3	Elevations
A4	Slab and Plumbing Plan
A5	Roof Plan
A6	Reflected Ceiling Plan
A7	Details
A8	Details
A9	Details
A10	Electrical Plan

Area Schedule (Gross Building)	
Area	Туре
2122 SE	Conditioned

2122 SF | Conditioned 2122 SF 1392 SF Unconditioned 1392 SF

A0

Revision Date

12/26/2024

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Cover, Location,

Notes

SHEET

Number

Date:

Drawn:

Description:

St

DESIGN

bobharrisdesign.com


bh@bobharrisdeign.com

352-317-6644

2351 SW 5th Avenue


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A1

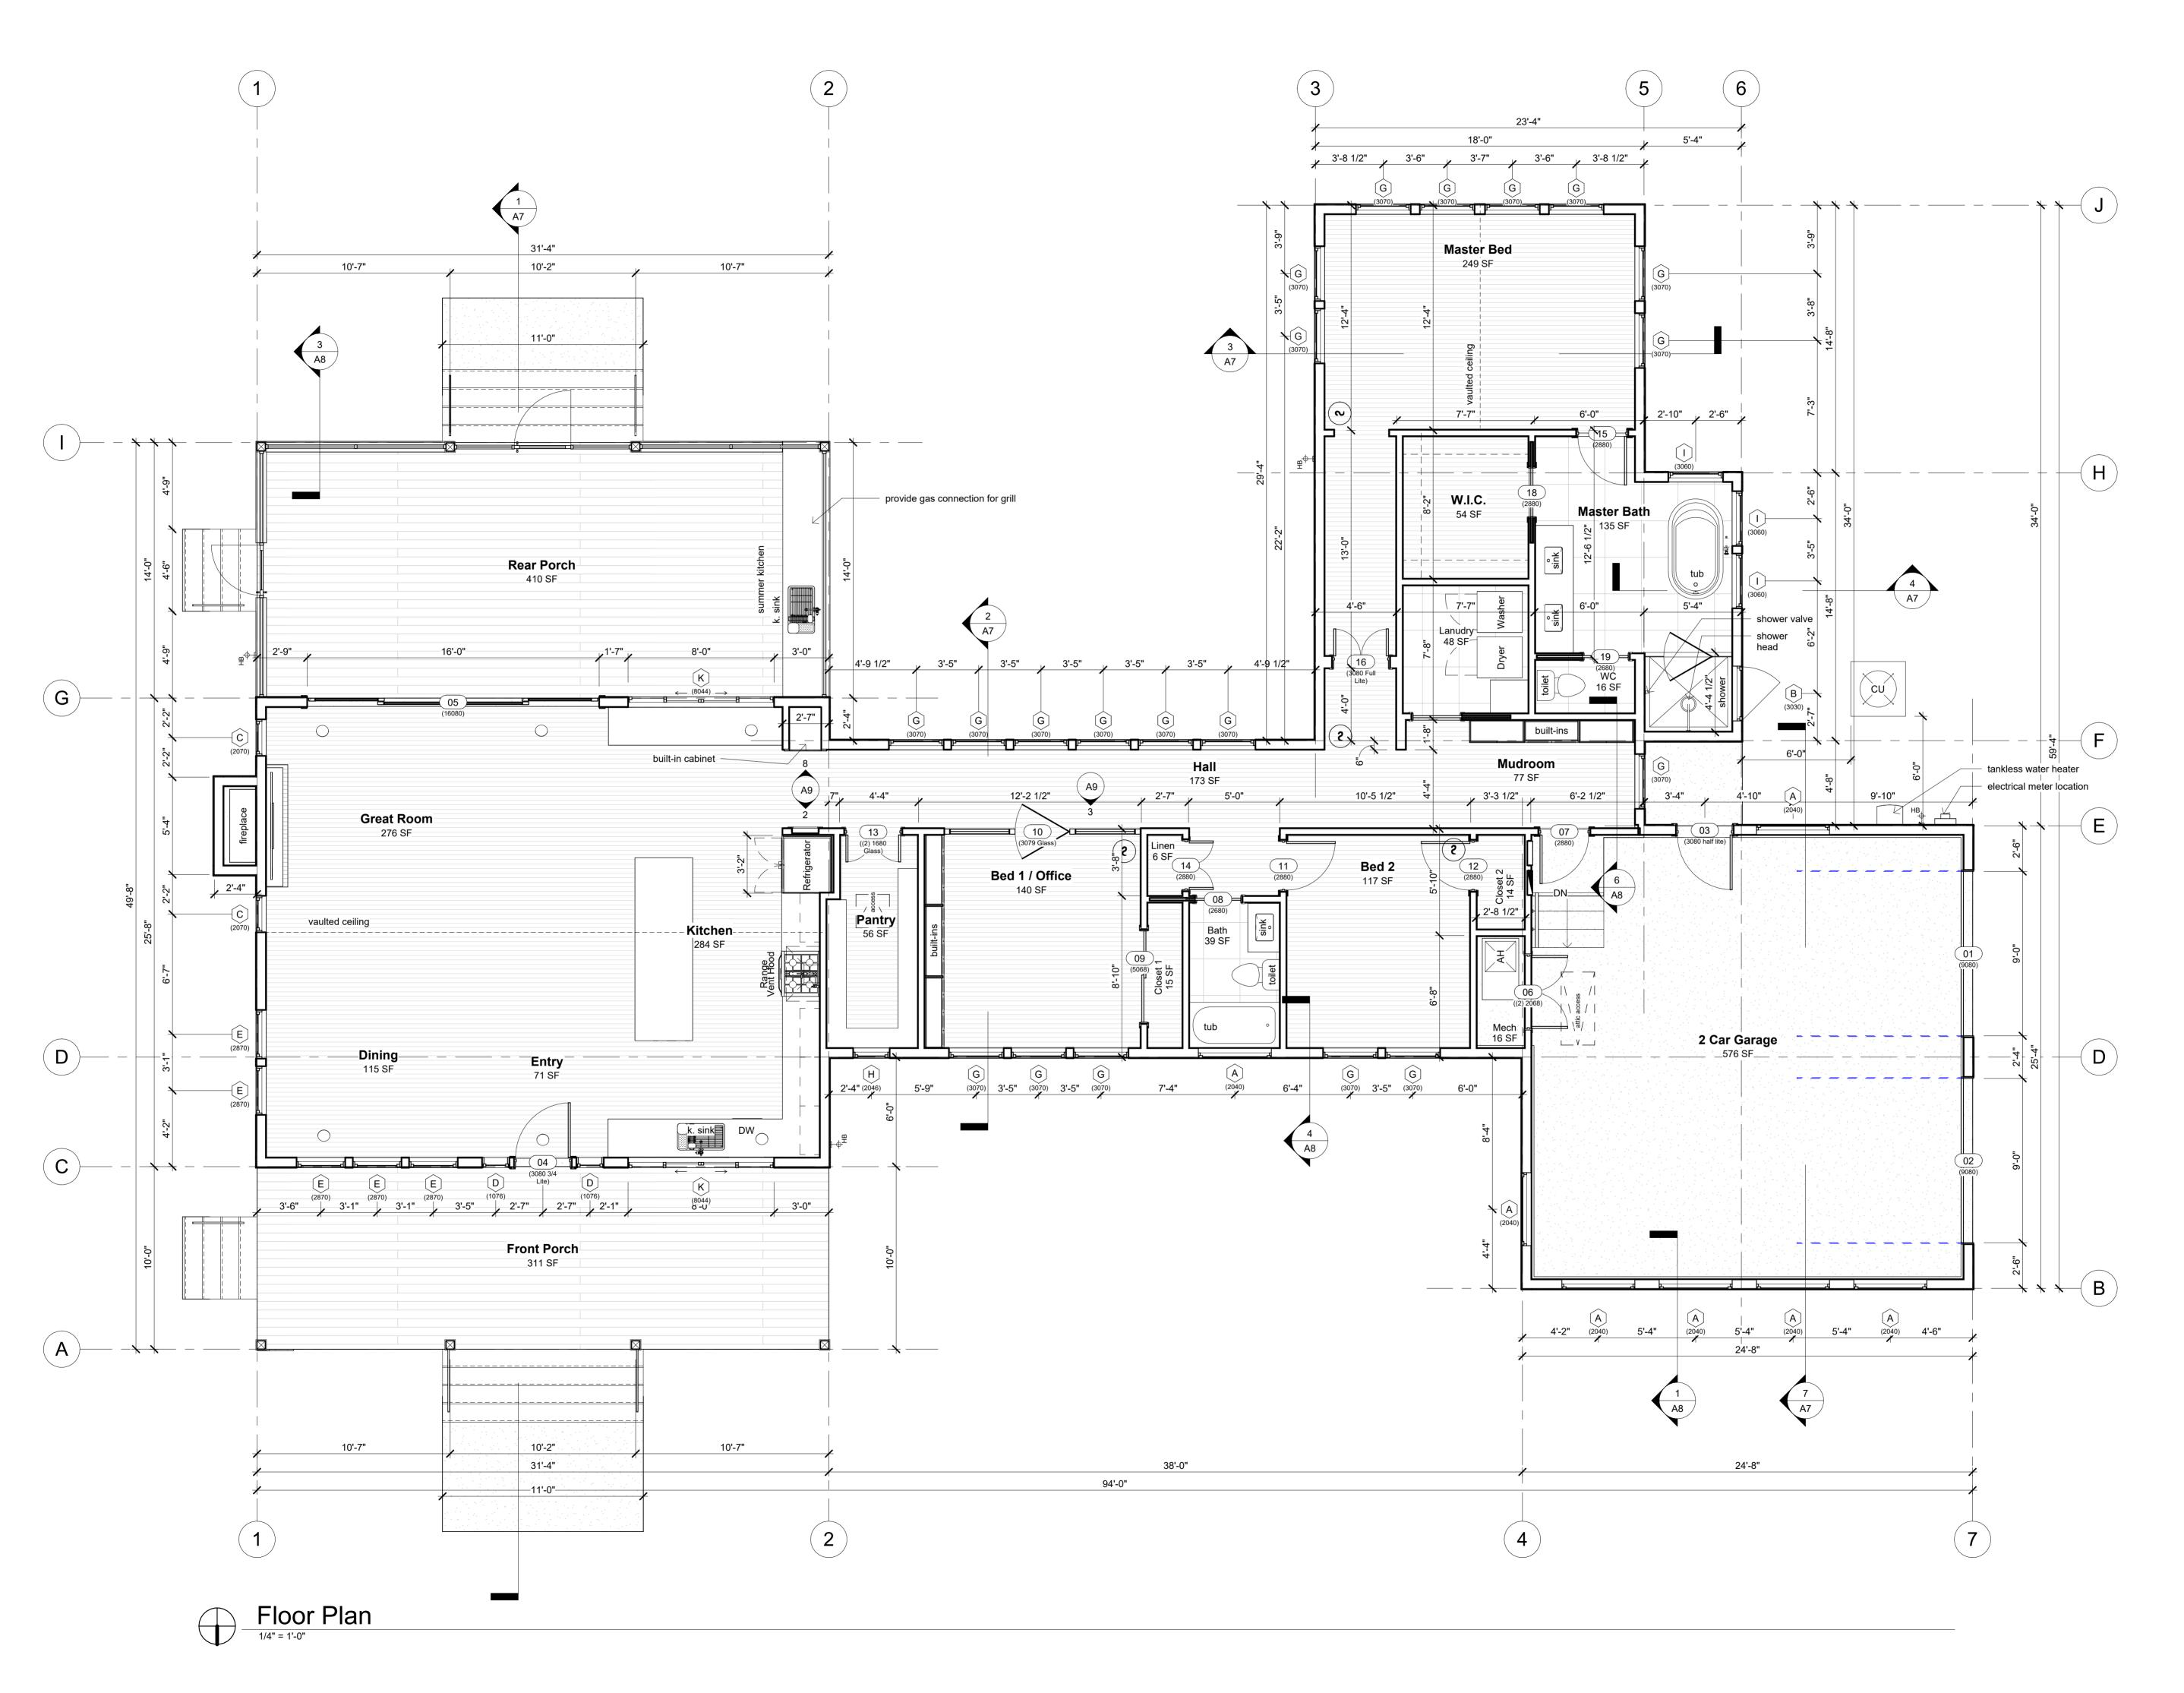

Window Schedule

Comments

Count

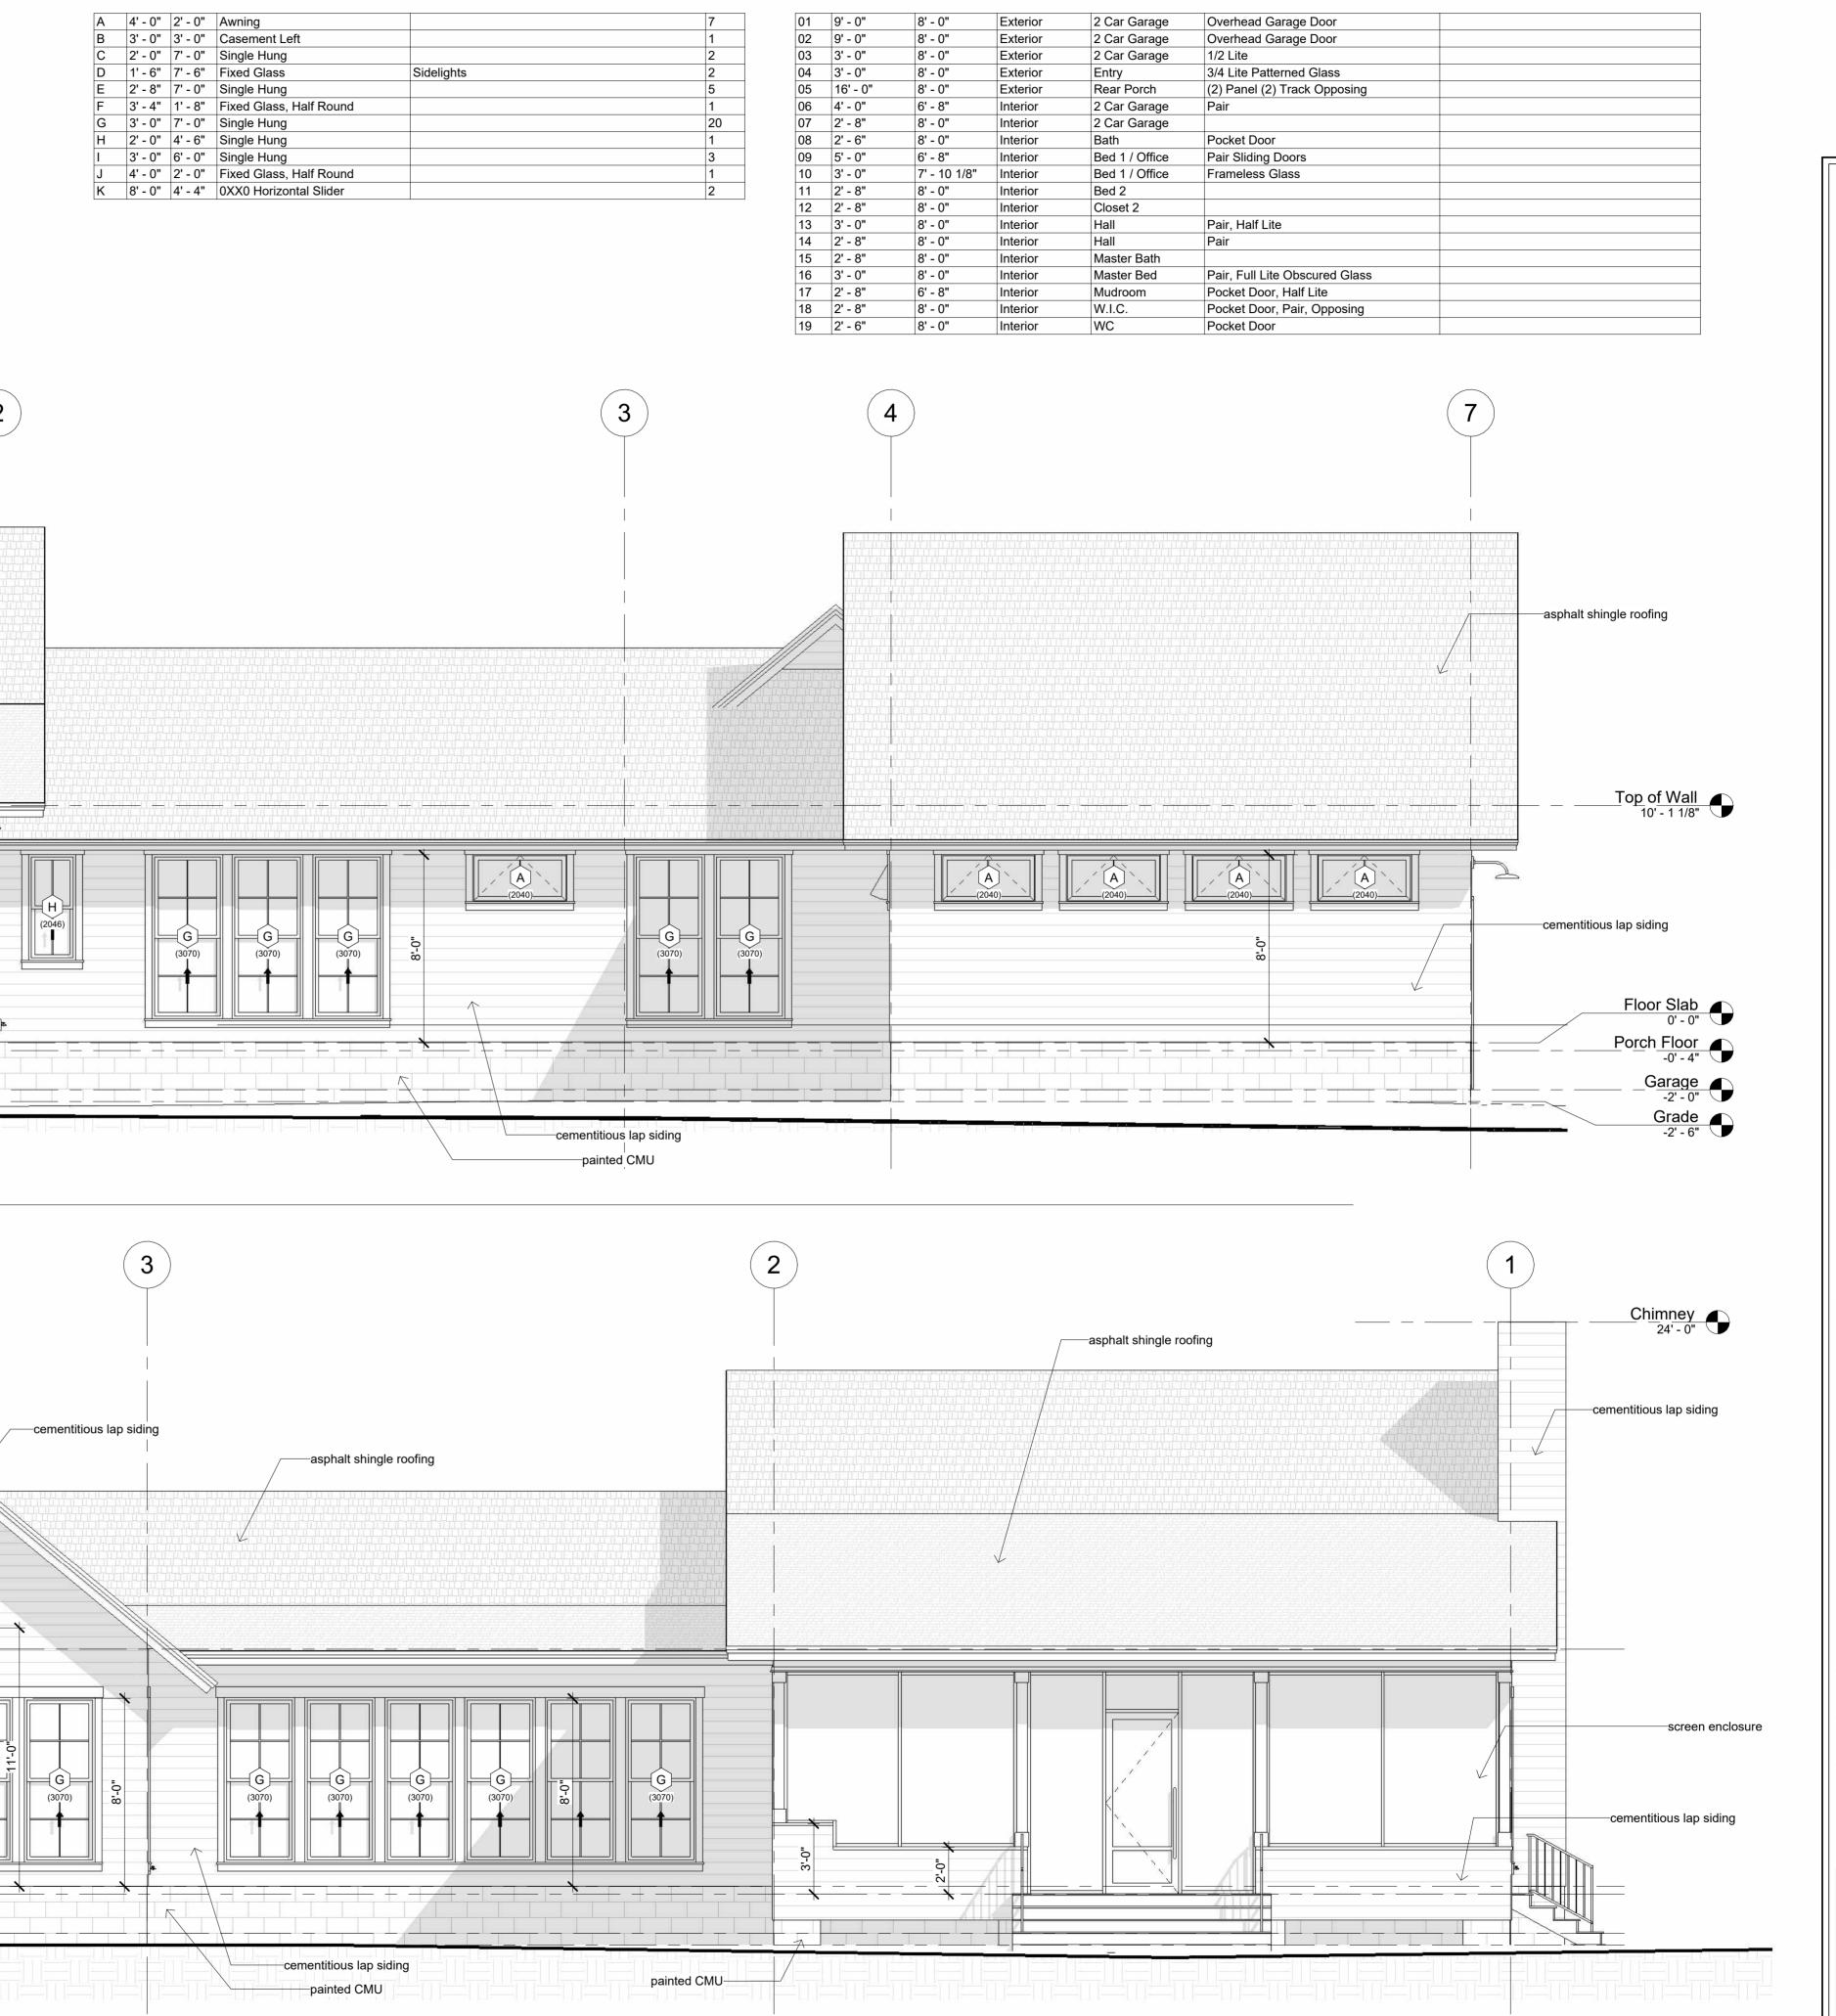Description

Mark Width Height

<u>Chimney</u> 24' - 0"

cementitious lap siding-

asphalt shingle roofing-

cementitious lap siding-

tankless water heater

electrical meter

Top of Wall 10' - 1 1/8"

Floor Slab
0' - 0"
Porch Floor
-0' - 4"

Garage
-2' - 0"

Grade
-2' - 6"

asphalt shingle roofing-

(04)

(5)

(2870)

North Elevation


1/4" = 1'-0"

South Elevation

1/4" = 1'-0"

(6)



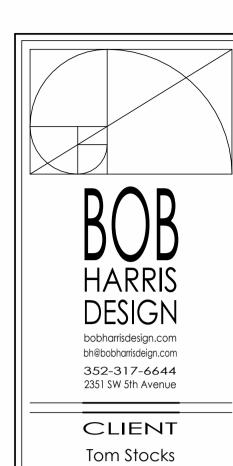

Home Stocks

Revision Date Number


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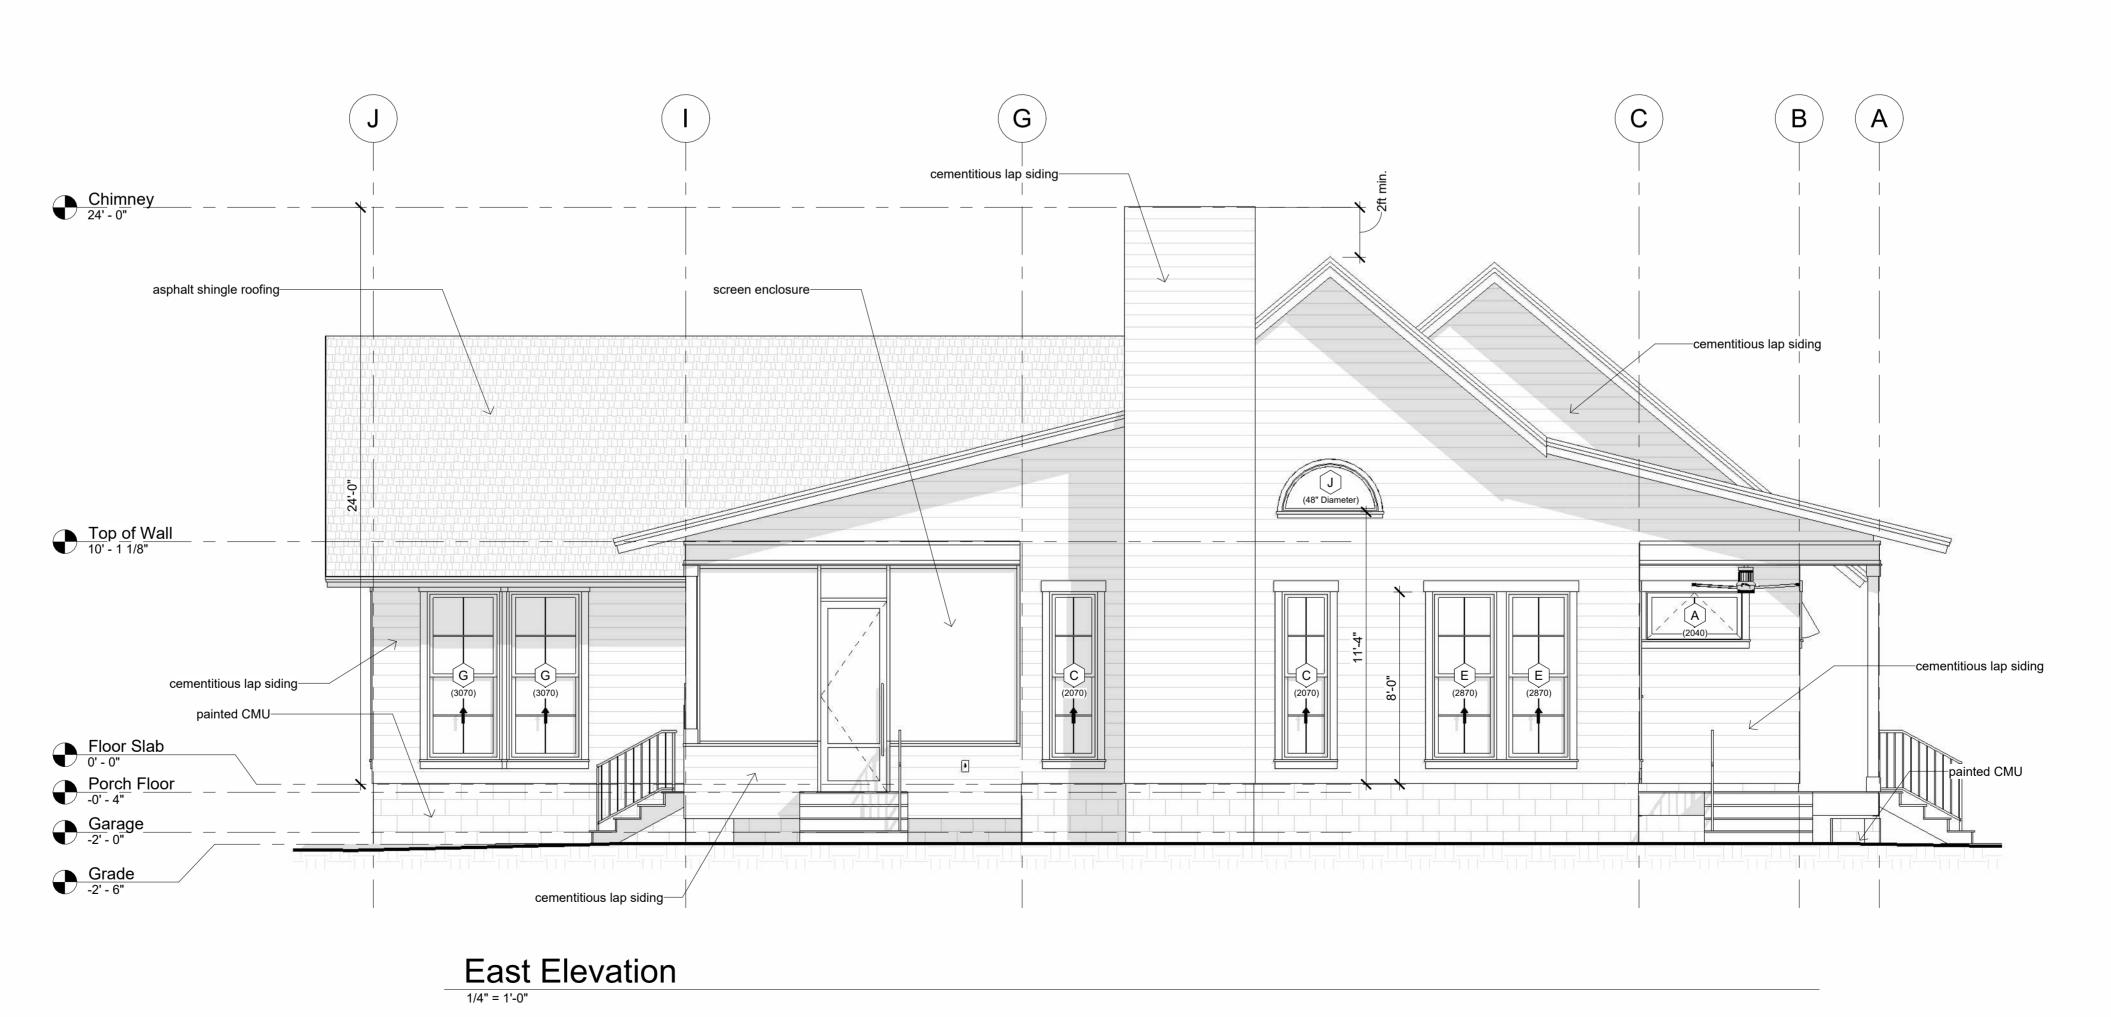
Bob Harris

Description: Elevations


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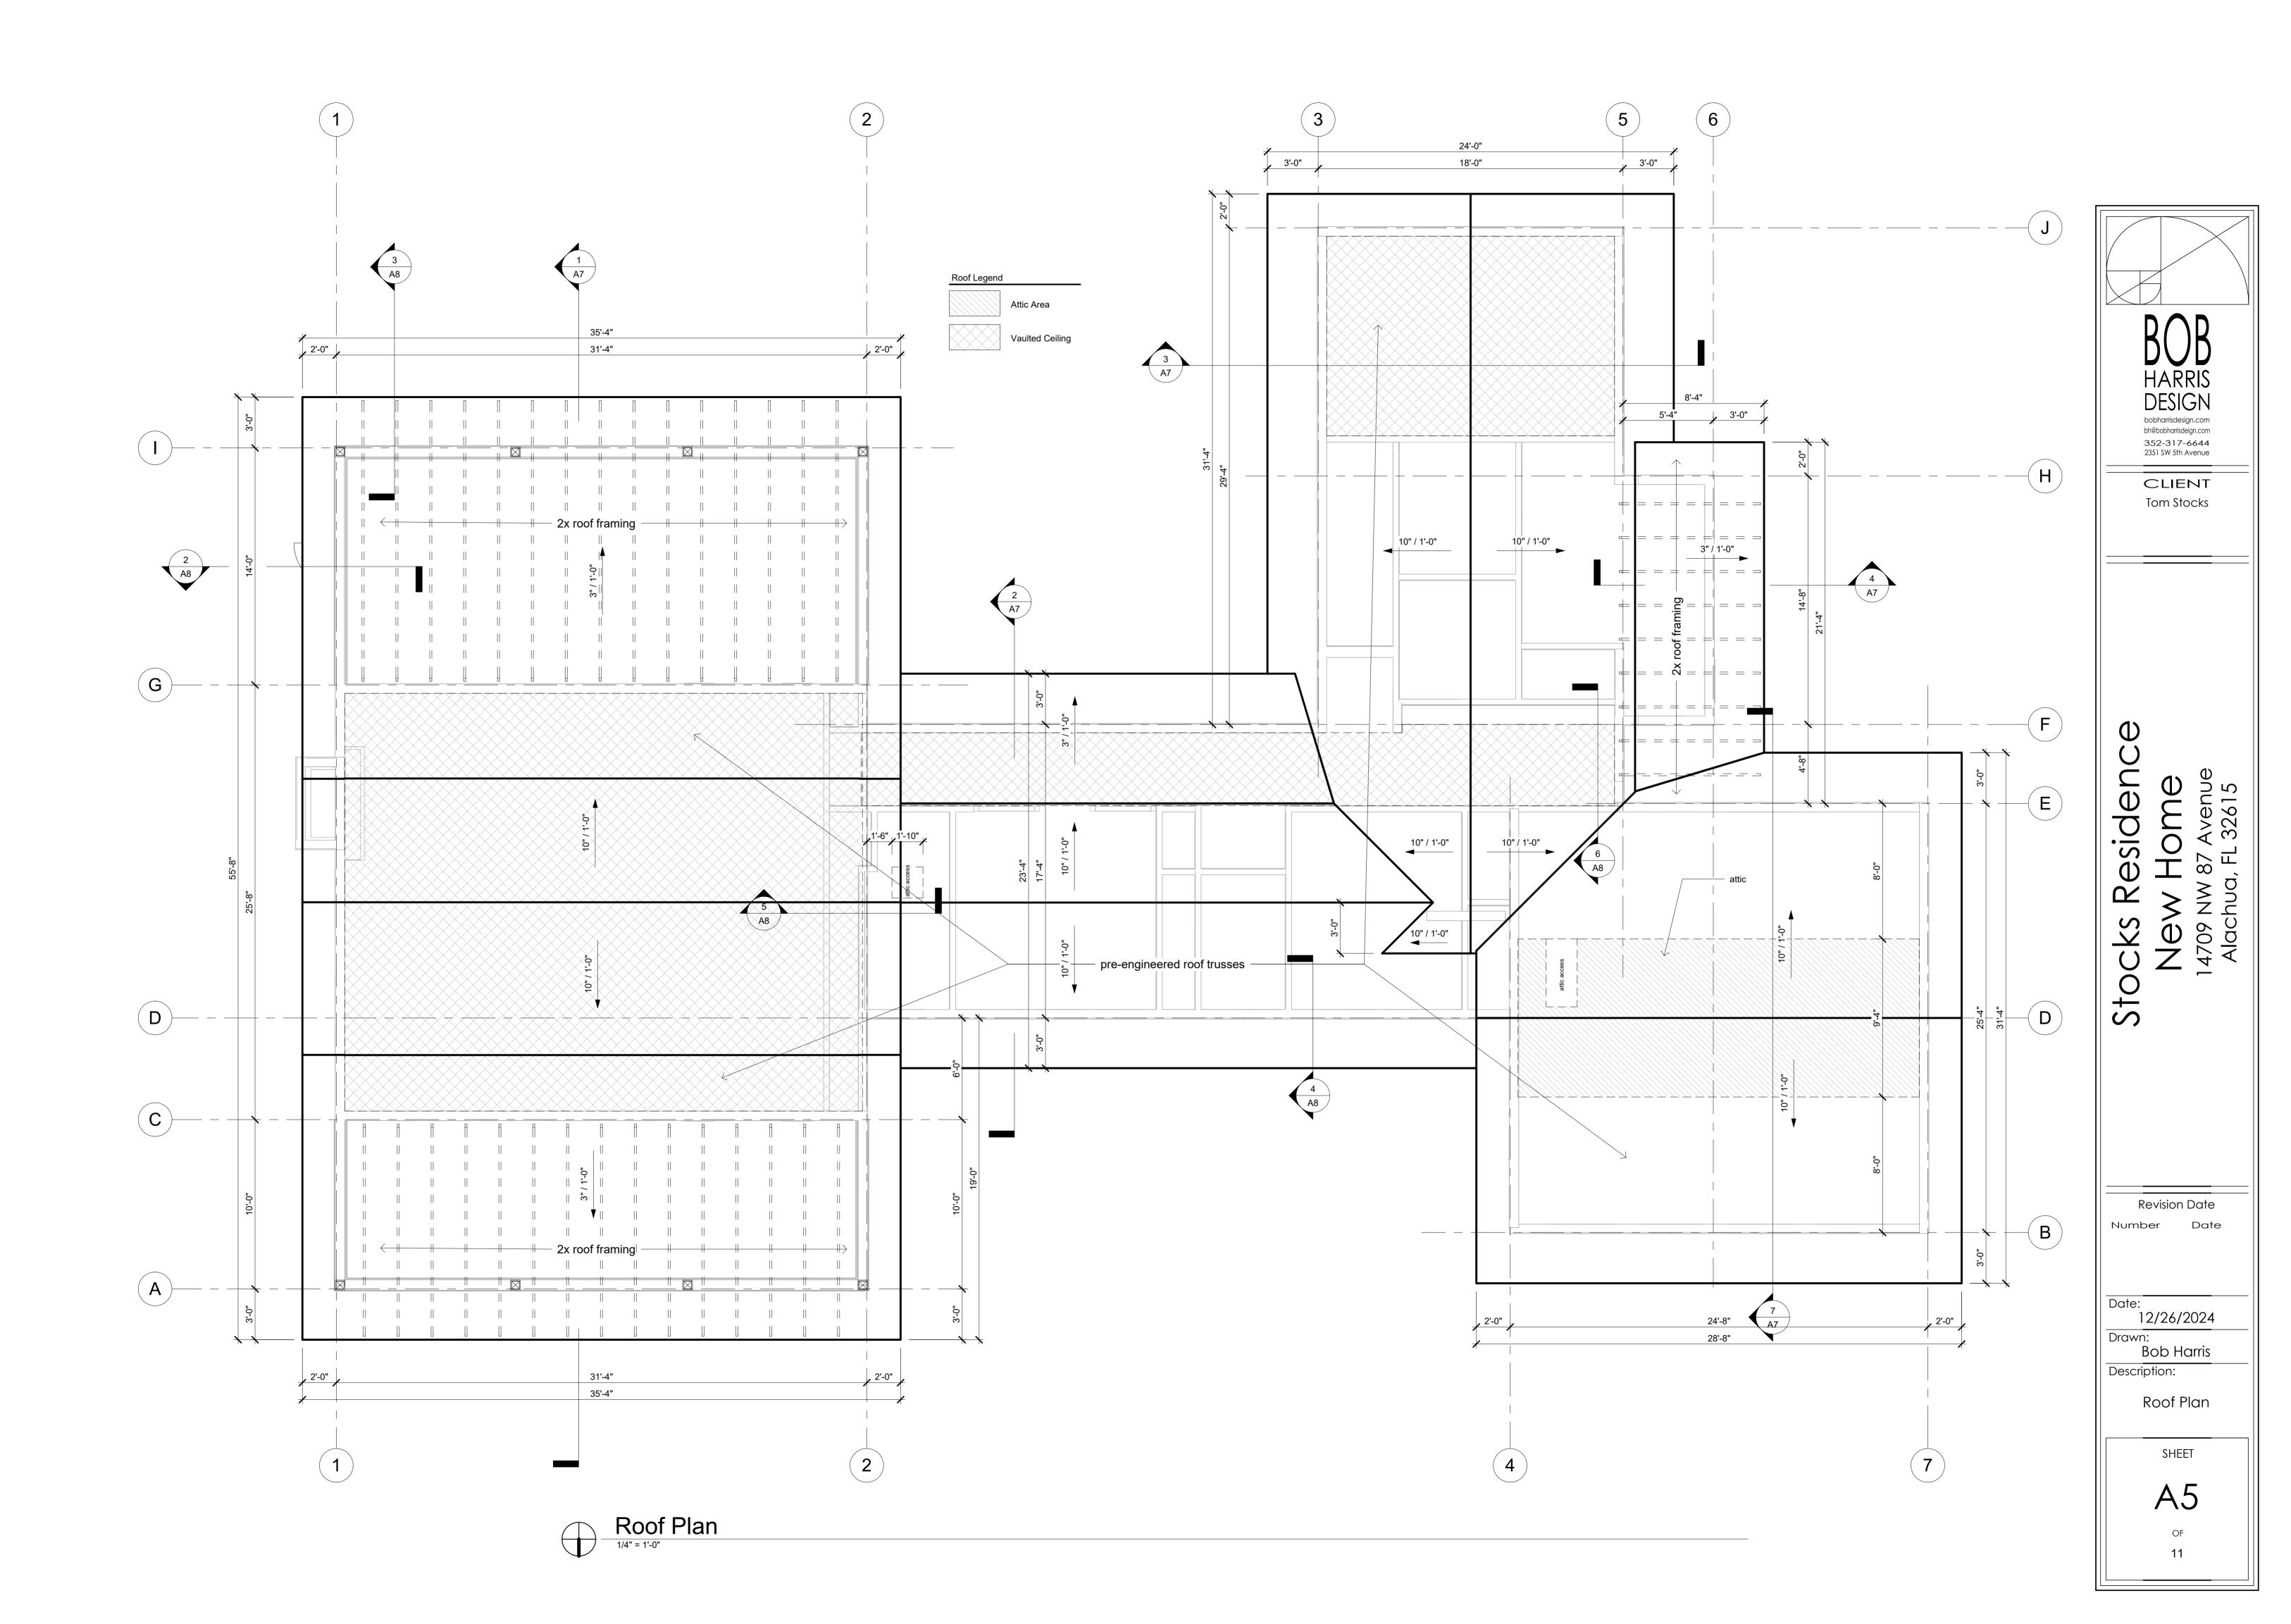
A2







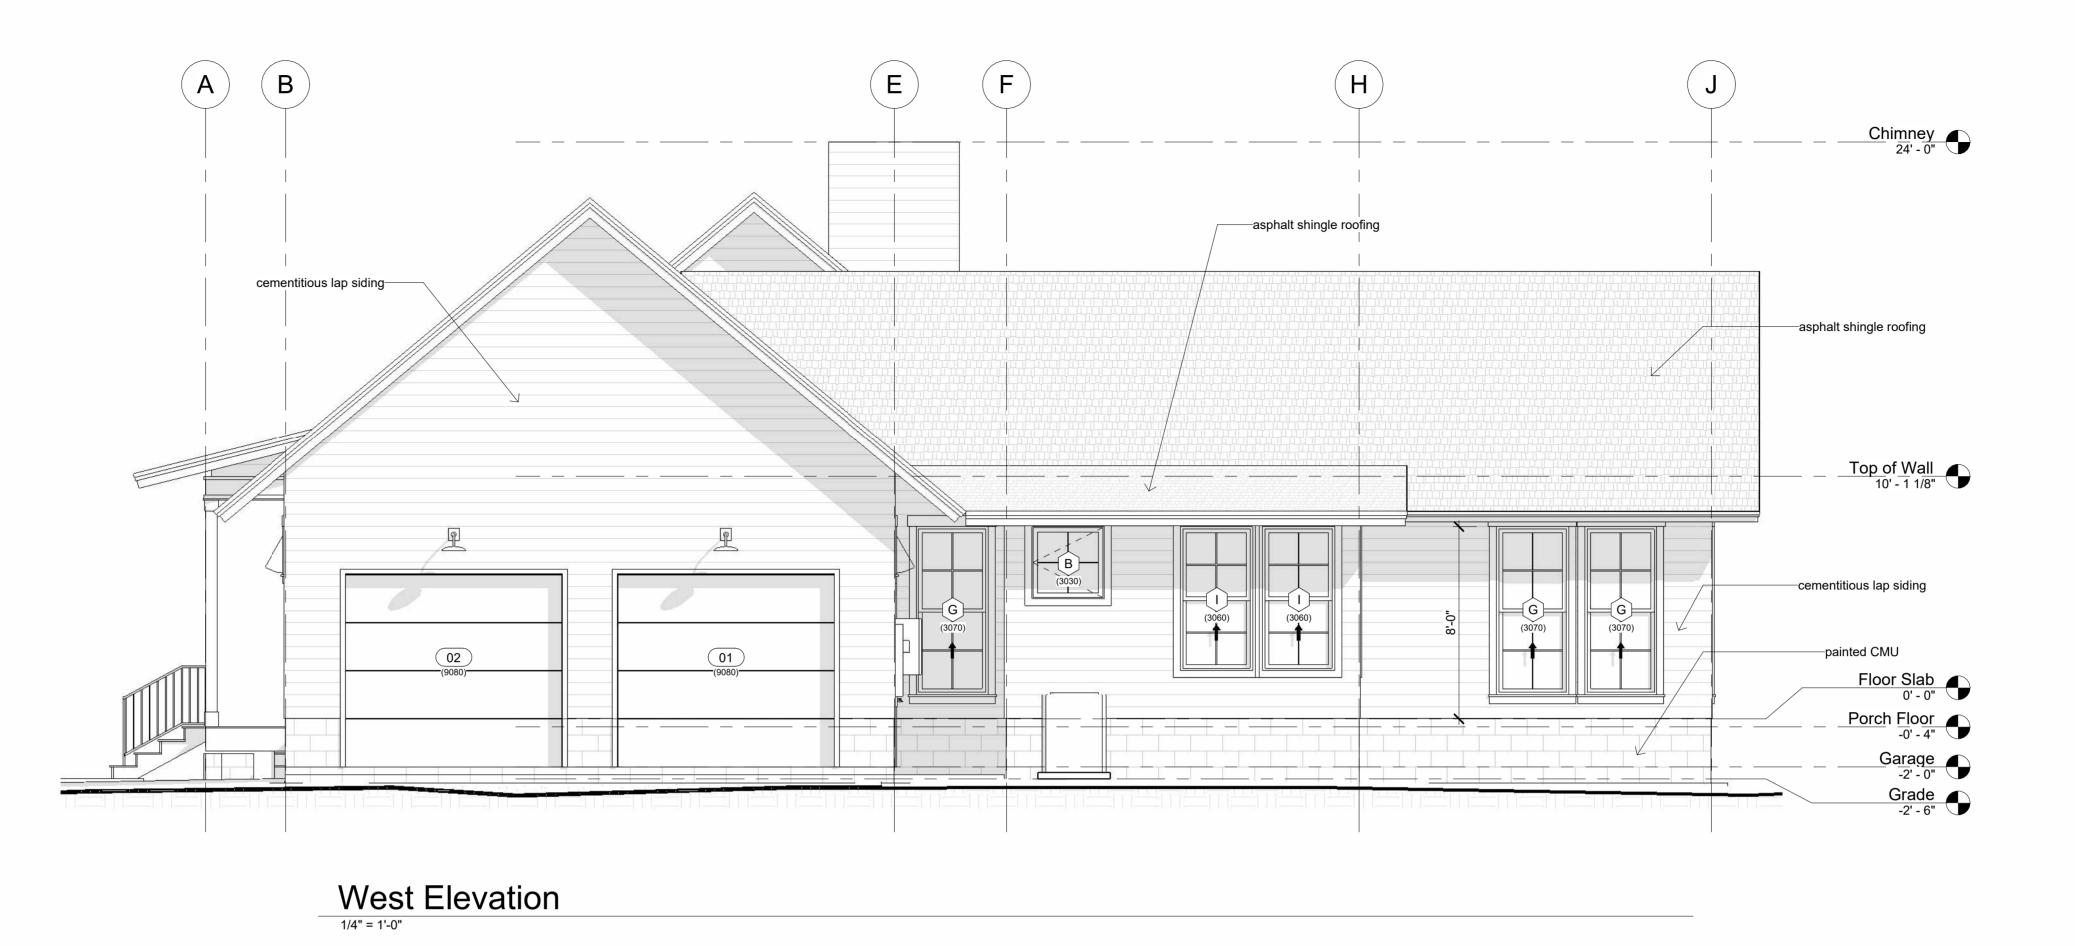



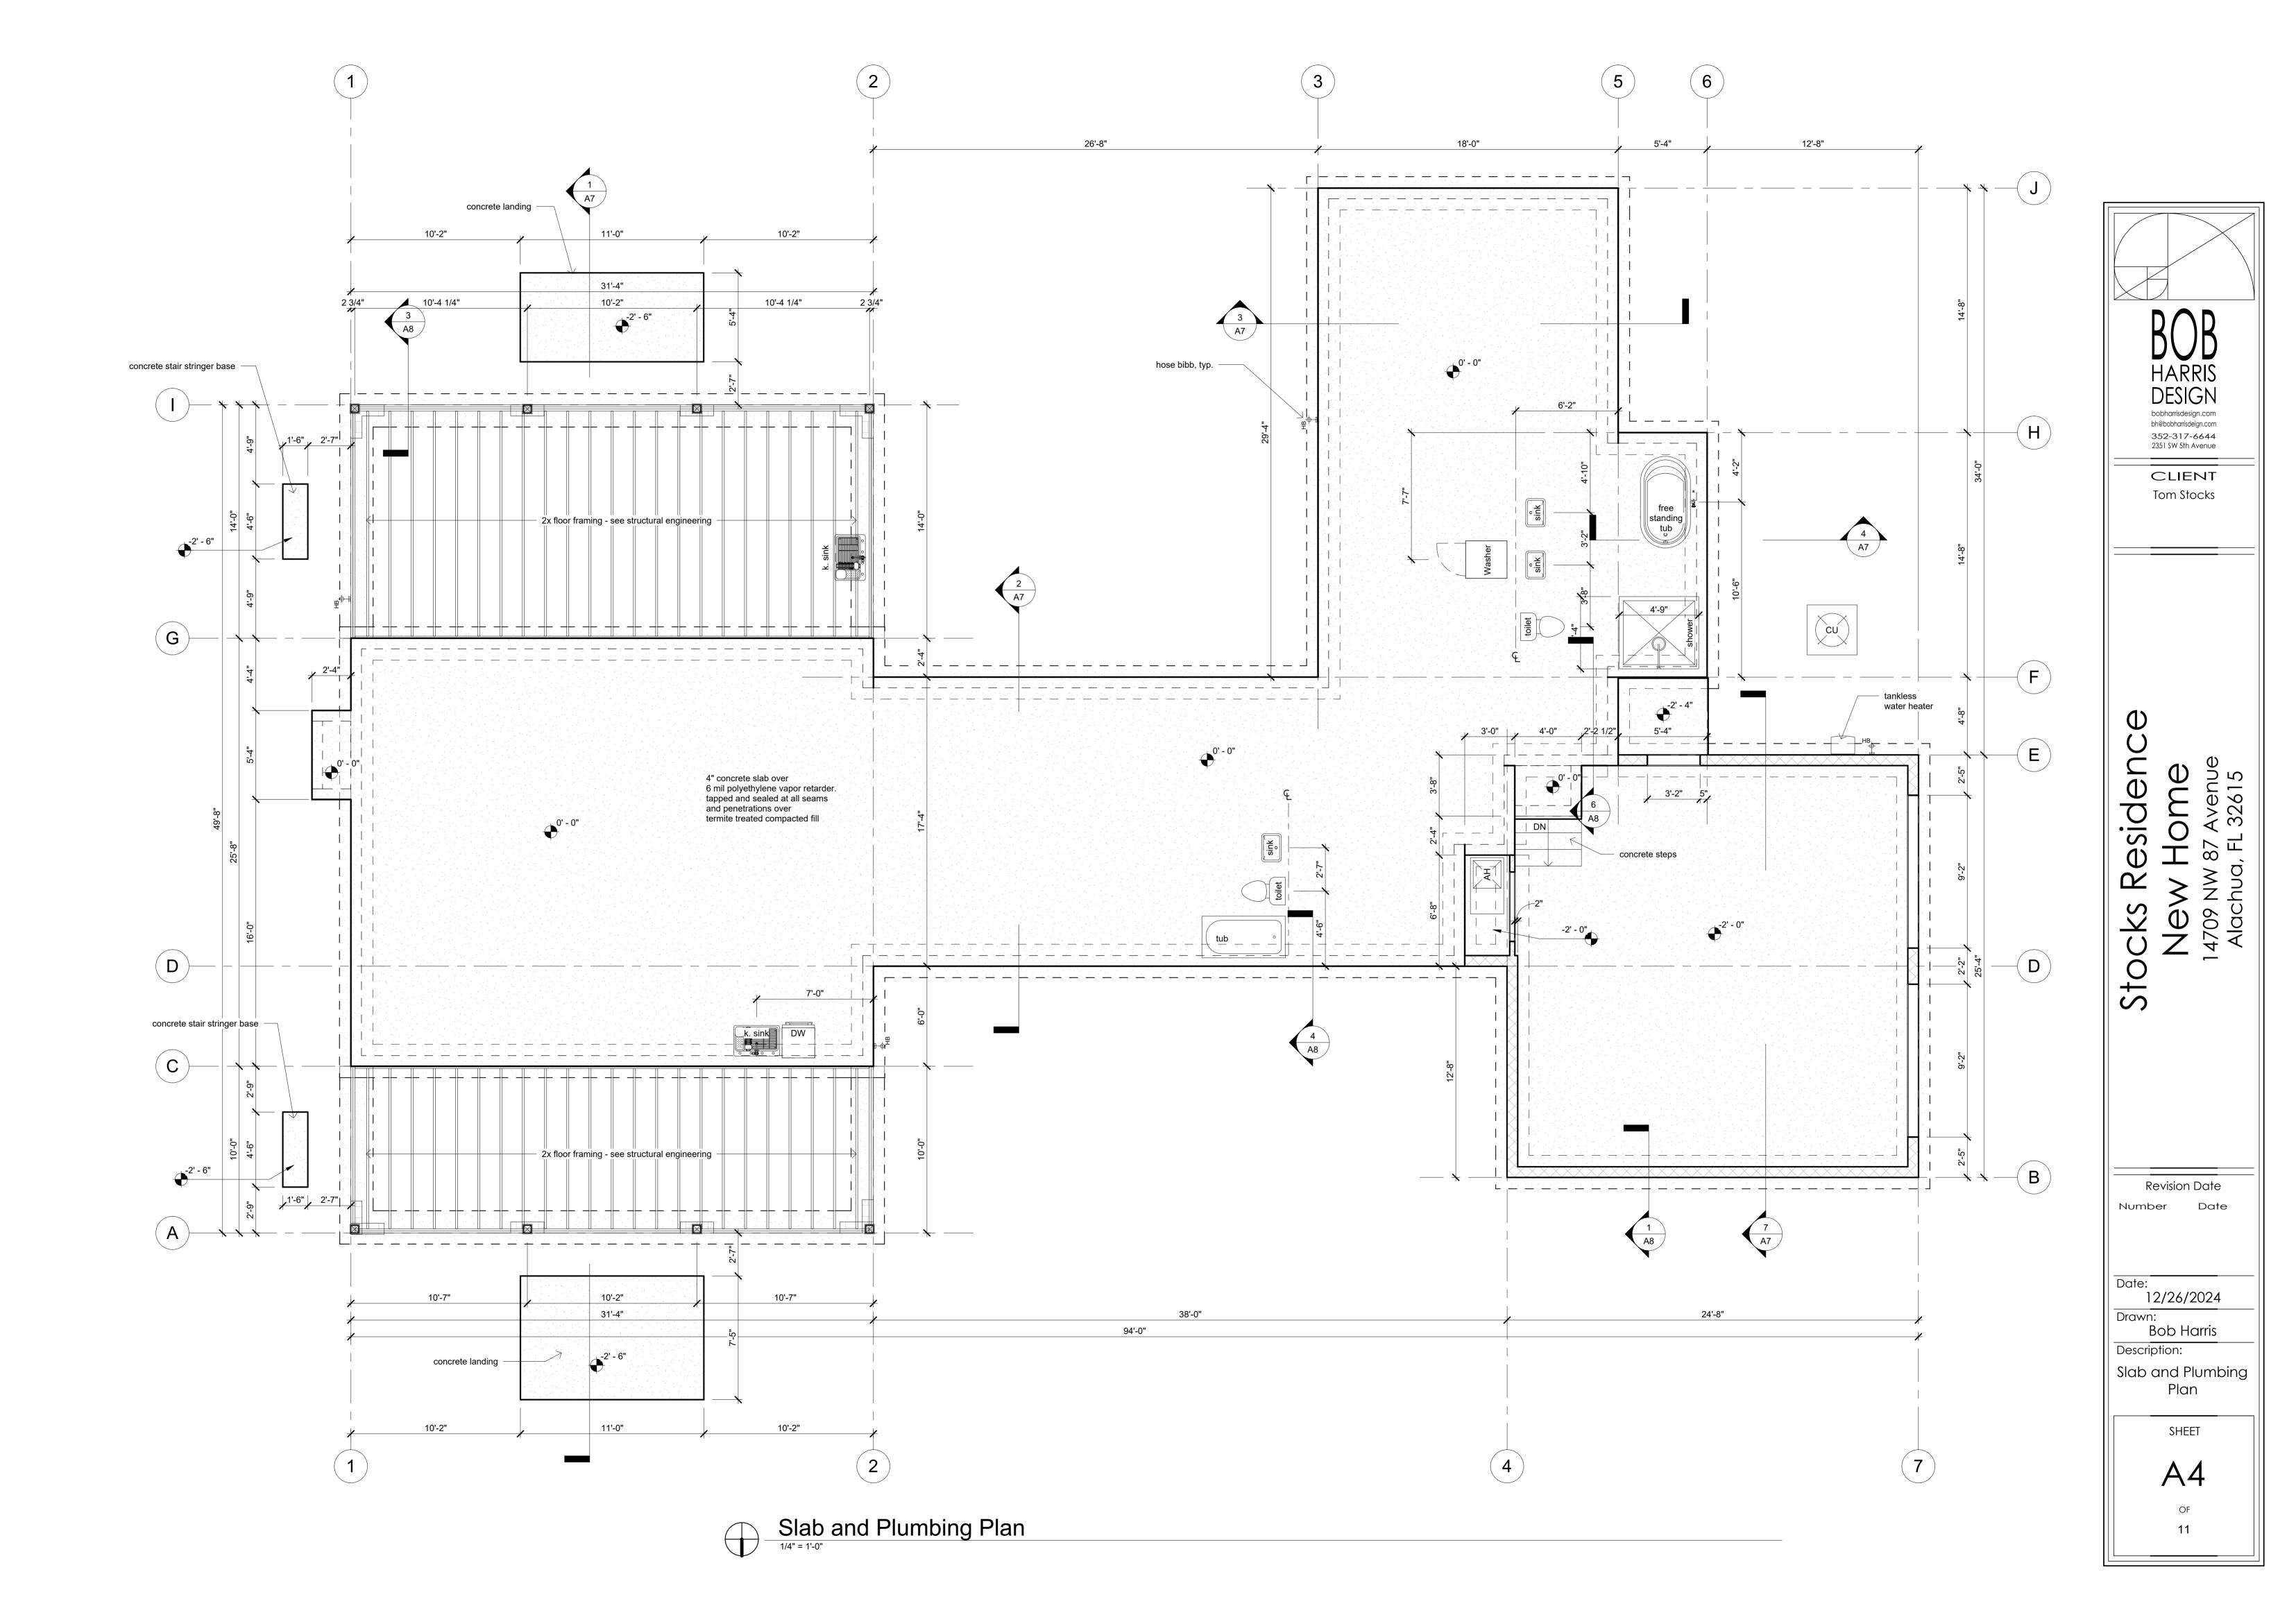

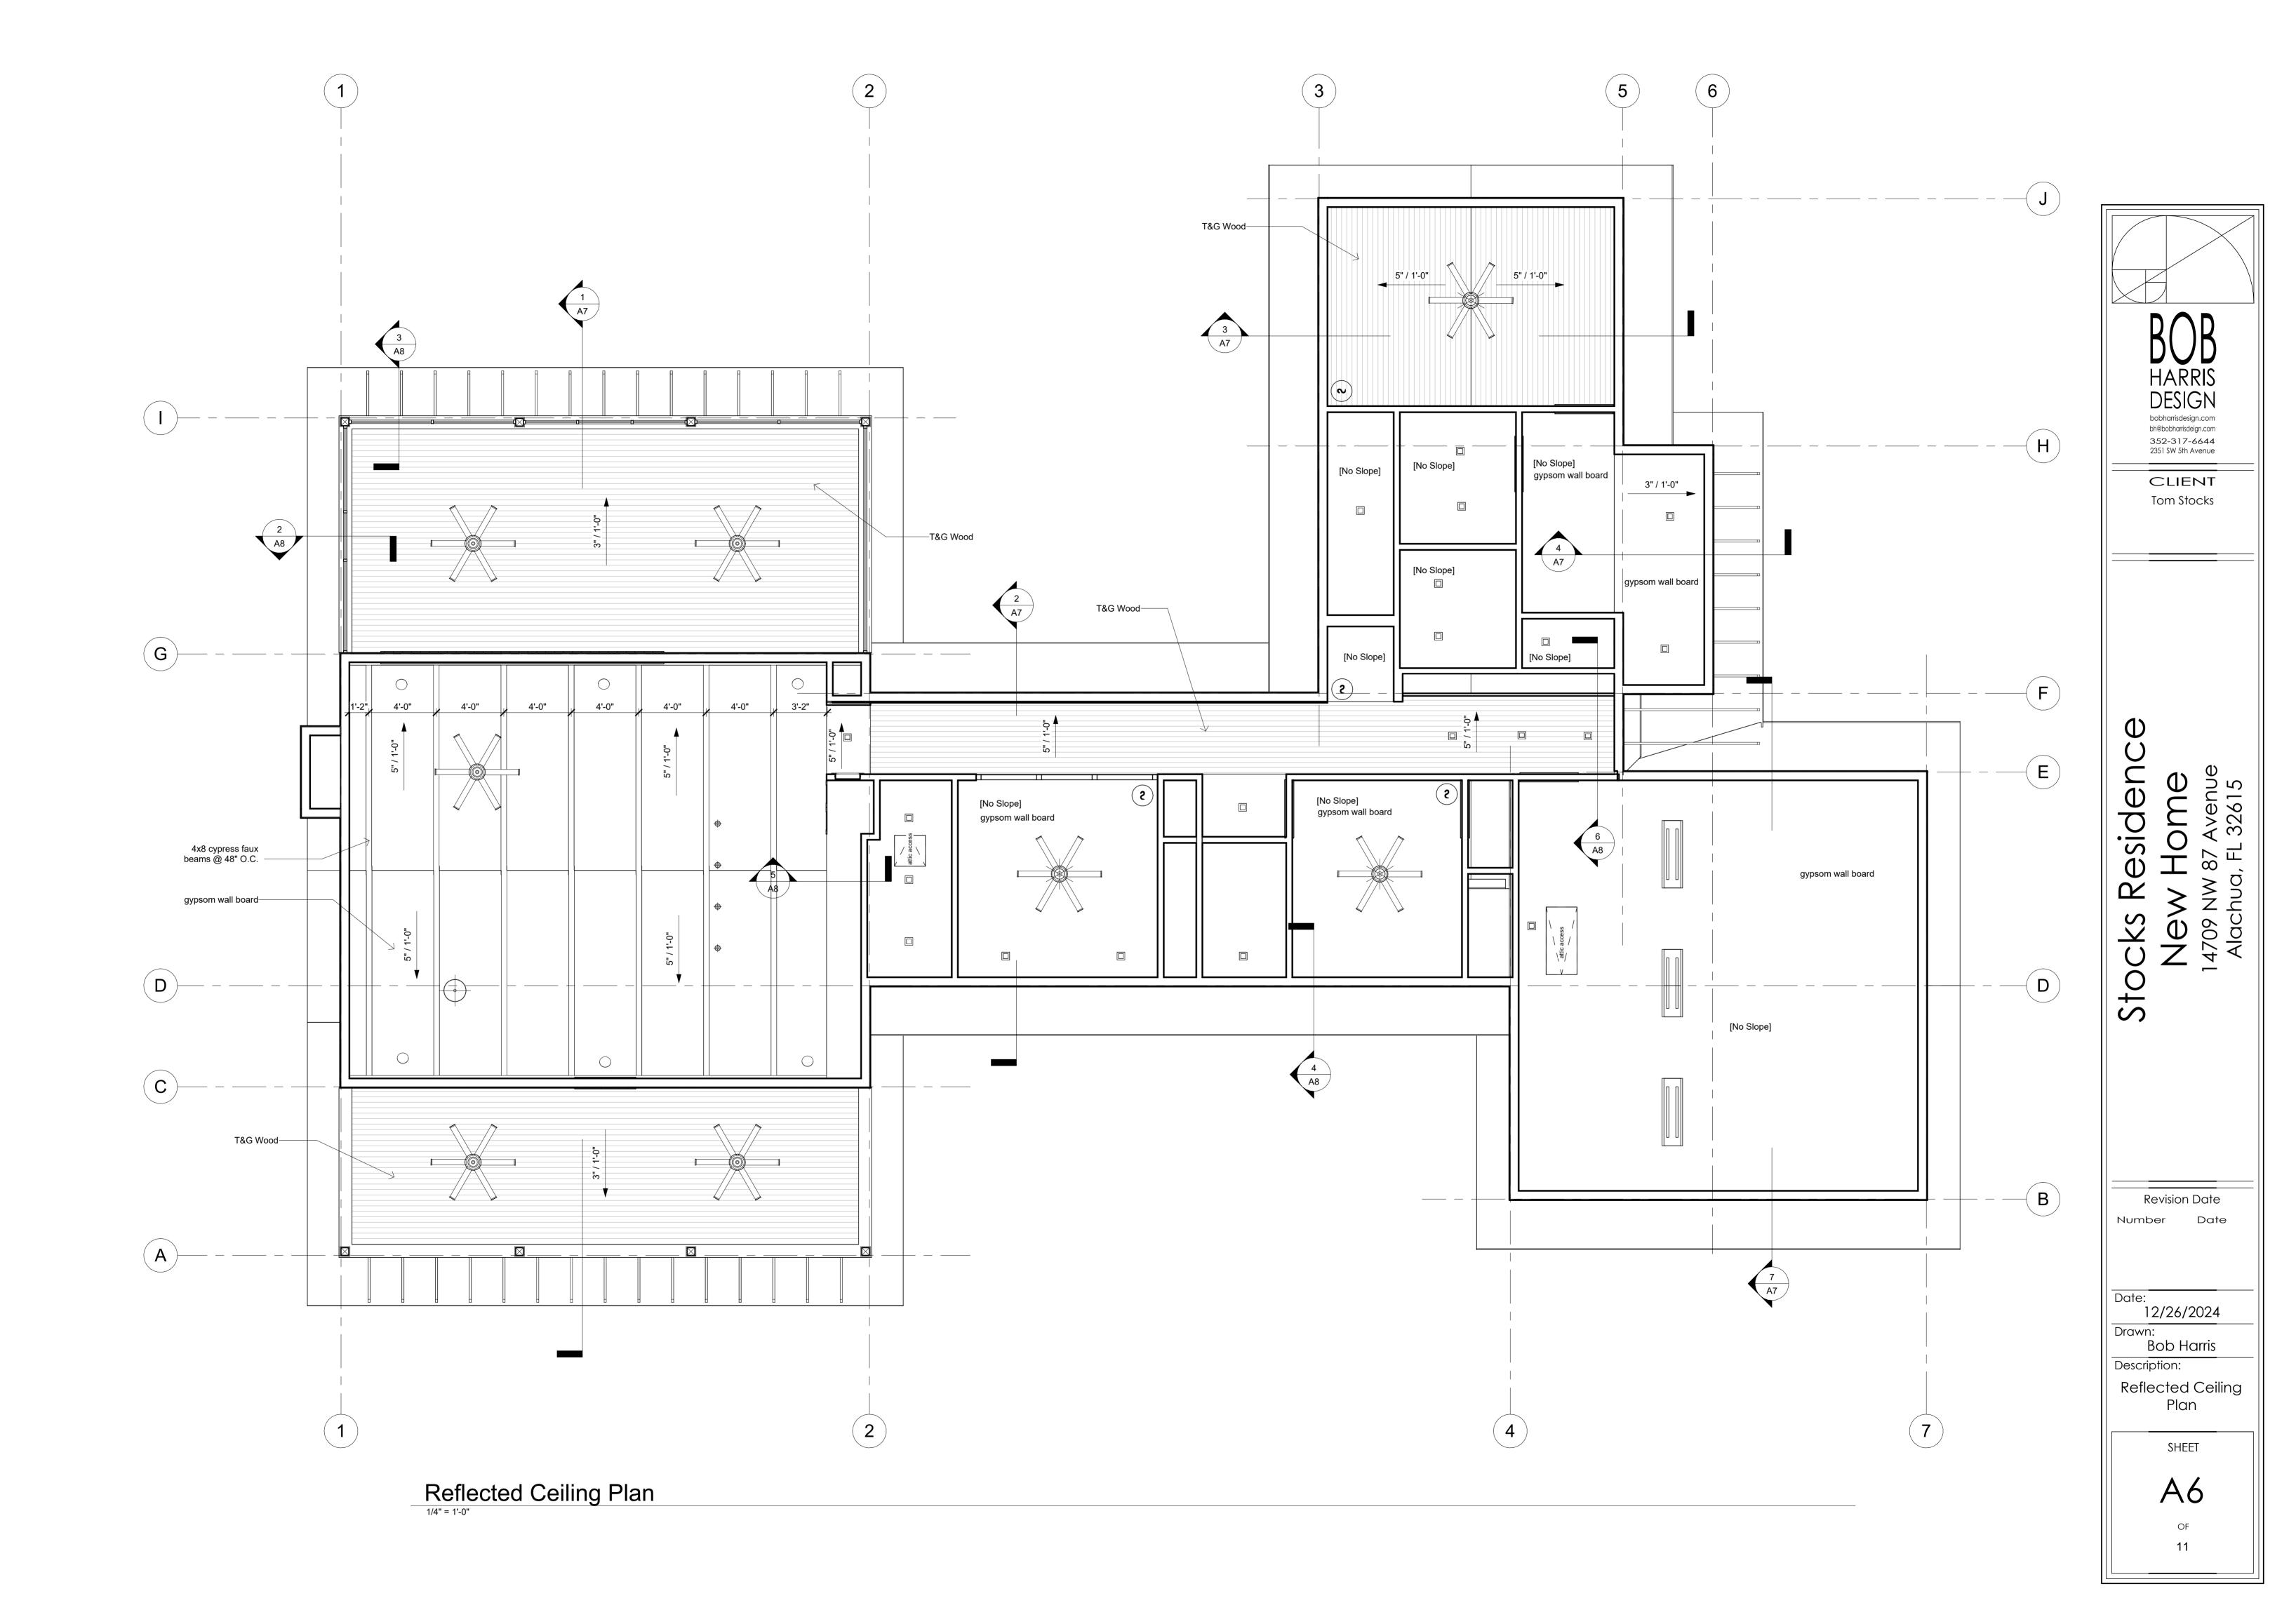

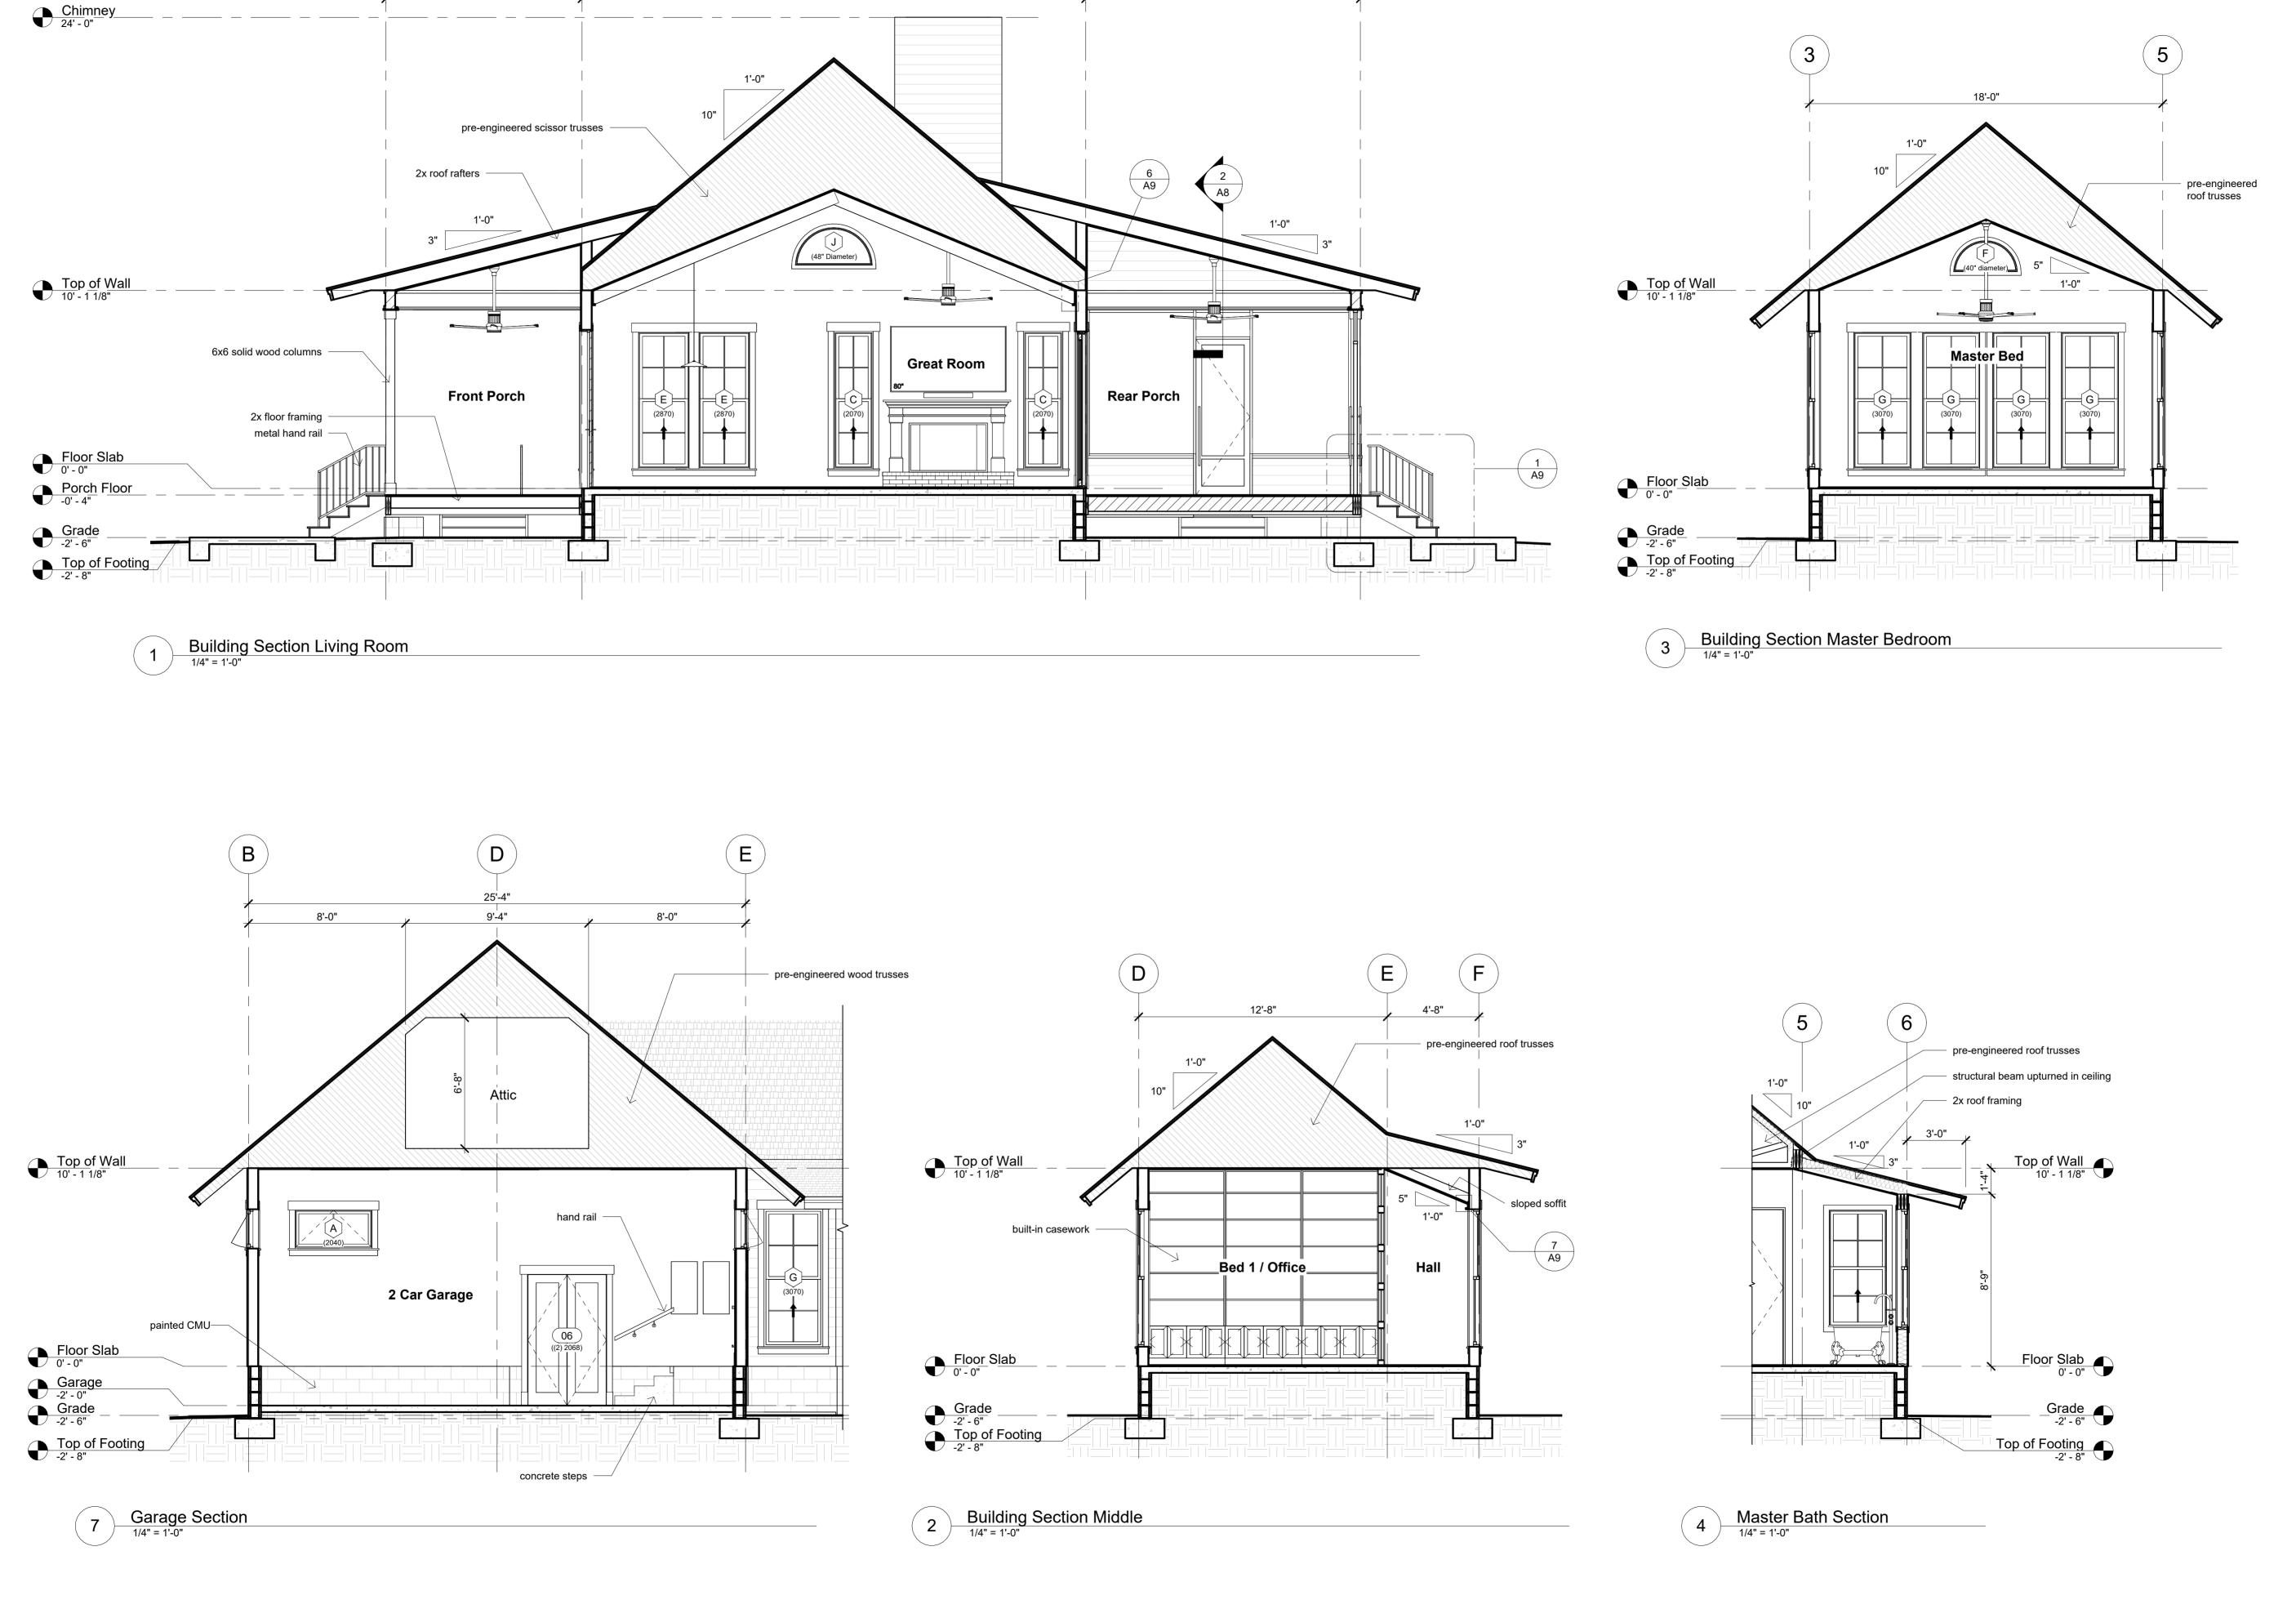


G

25'-8"

C

A

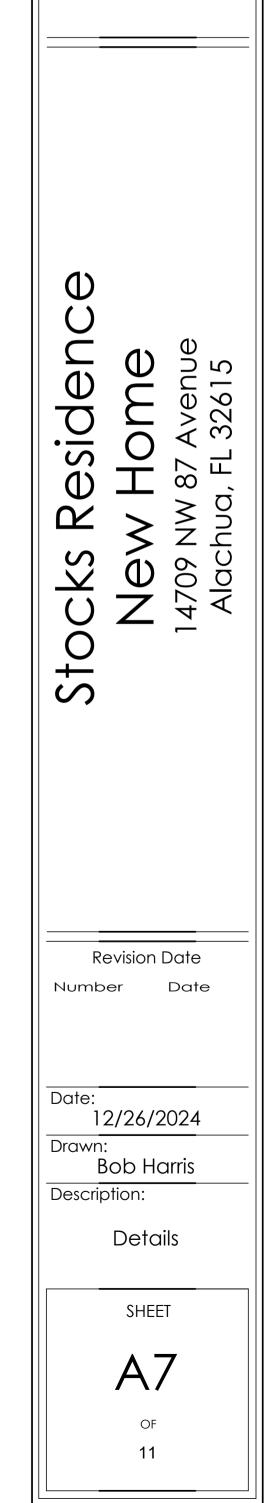



HARRIS DESIGN bobharrisdesign.com bh@bobharrisdeign.com


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see typical wall section for roof assembly

vented soffit

beam - see structural

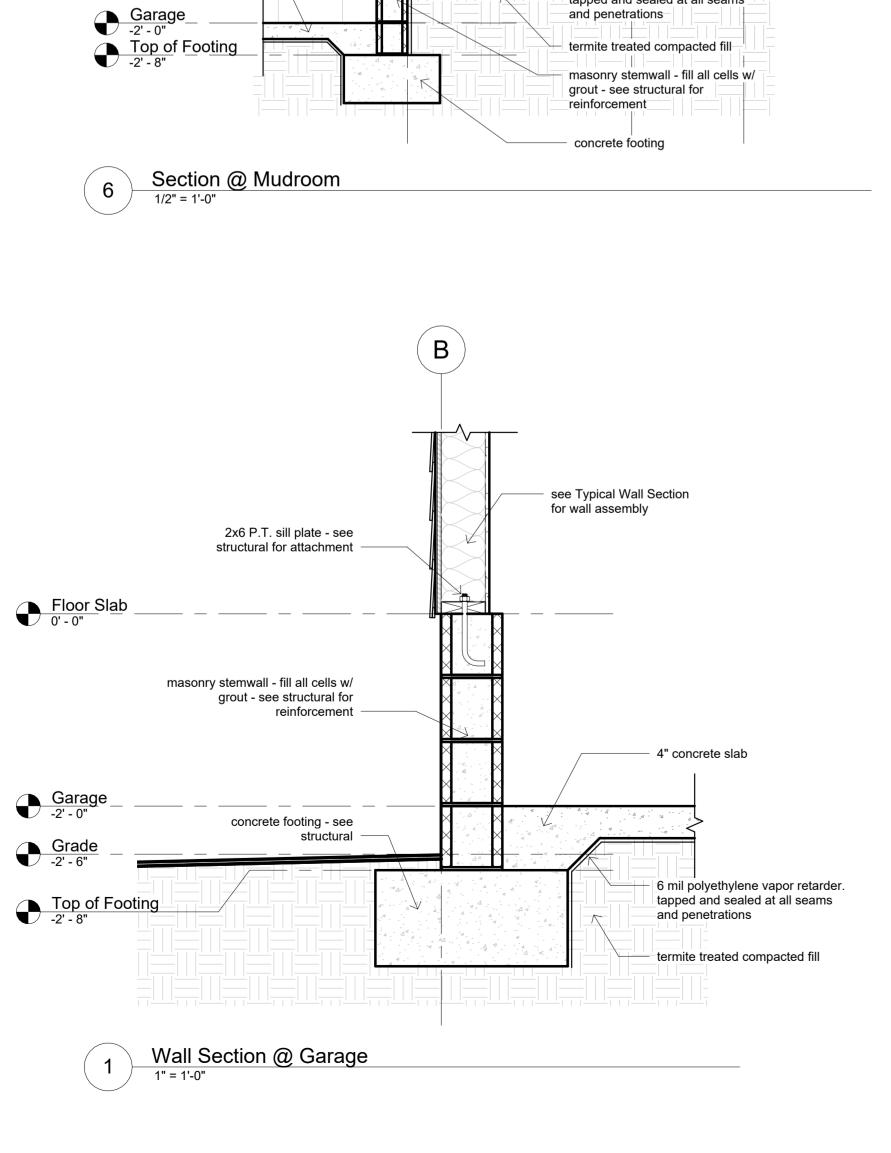solid 6x6 S4S cypress column

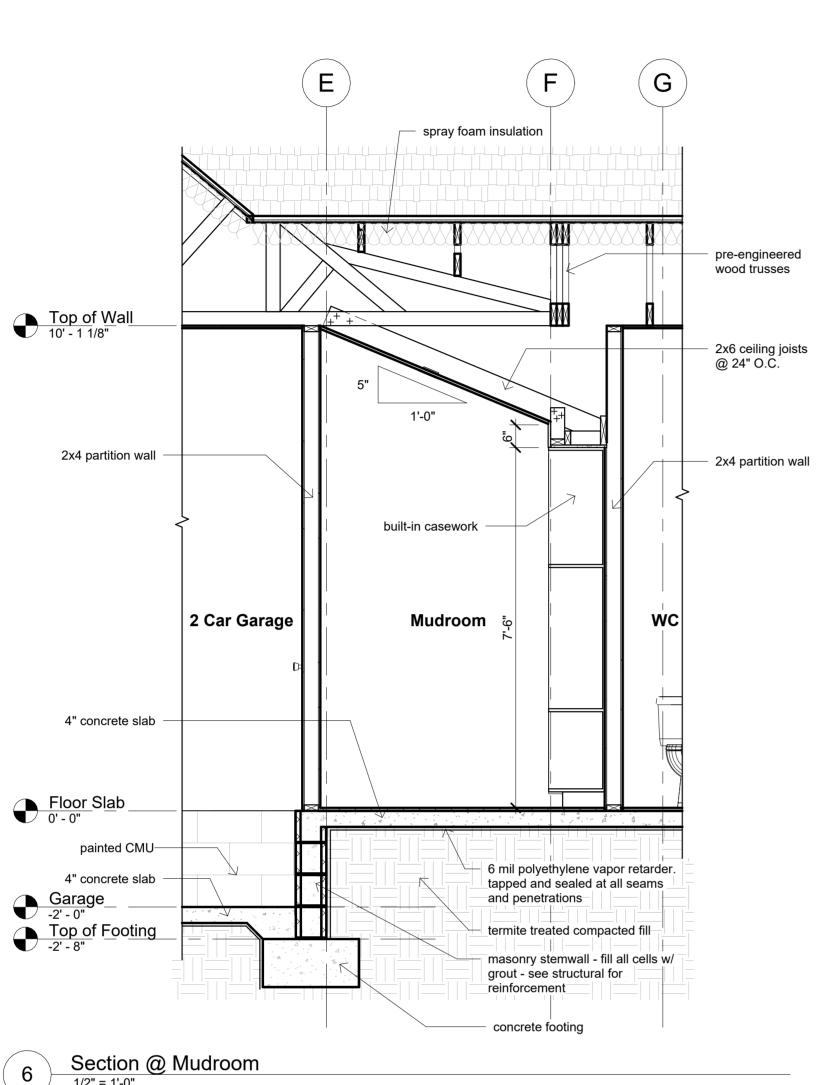Top of Wall 10' - 1 1/8" 3'-0"

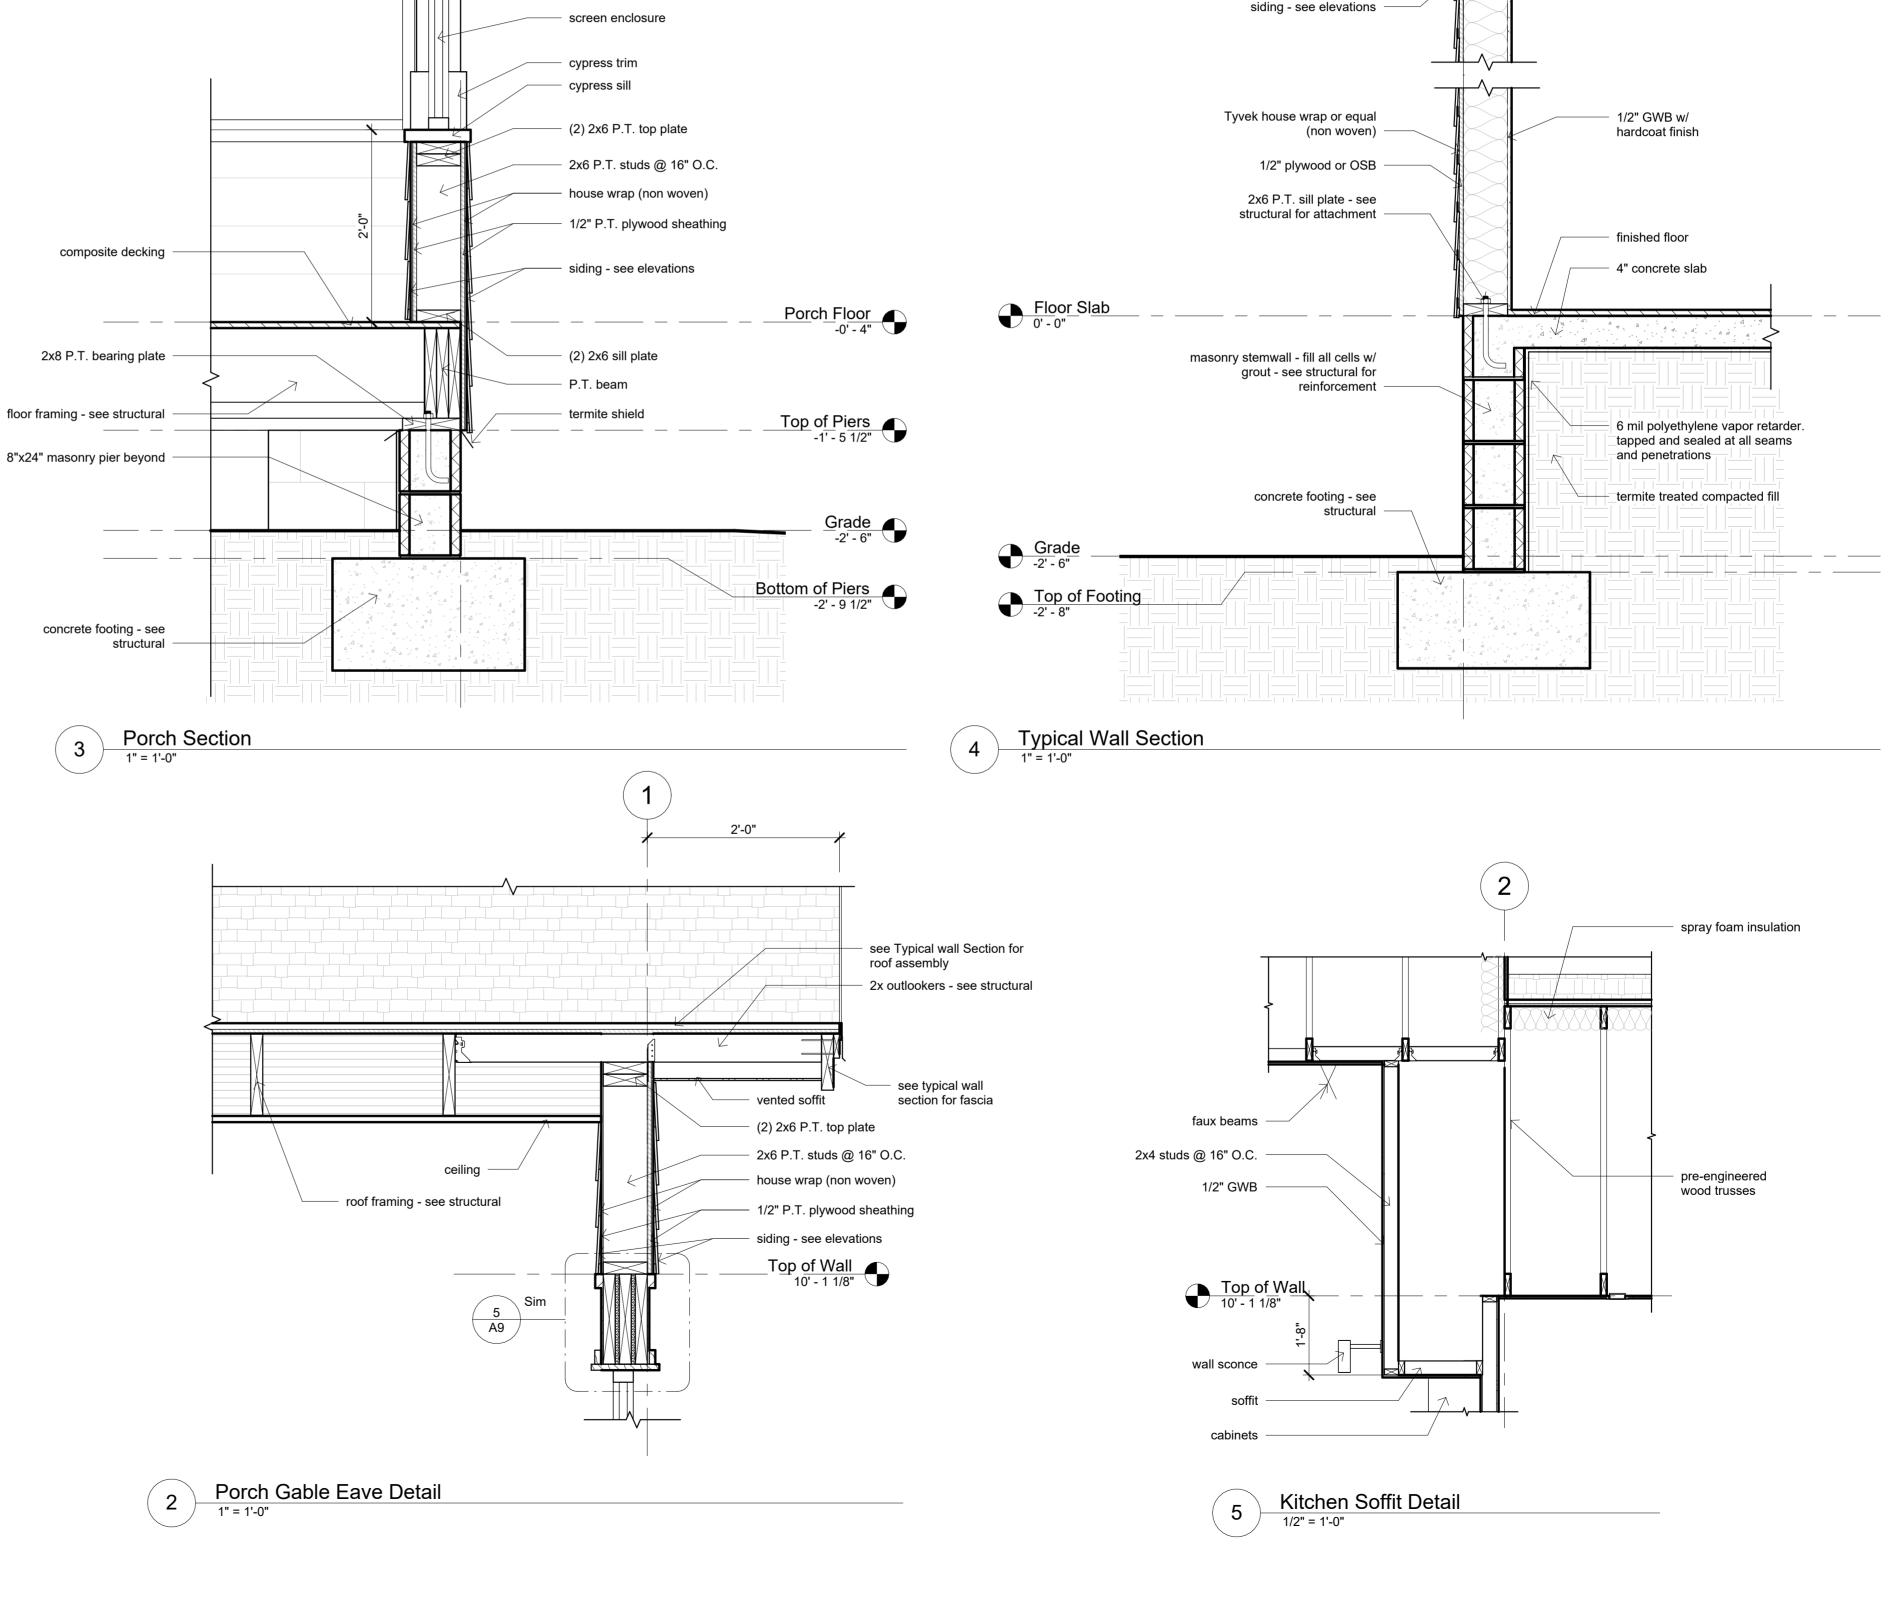roof material - see elevations peel and stick roof underlayment

5/8" or 1/2" OSB sheathing pre-engineered wood trusses

hurricane clip - see structural

Top of Wall
10' - 1 1/8"

aluminum drip edge

1x P.T. blocking

2x6 sub fascia

insulation block

vented Hardie Soffit




spray foam insulation

5/8" GWB ceiling

(2) 2x6 top plate

5 1/2" insulation

2x6 studs @ 16" O.C.

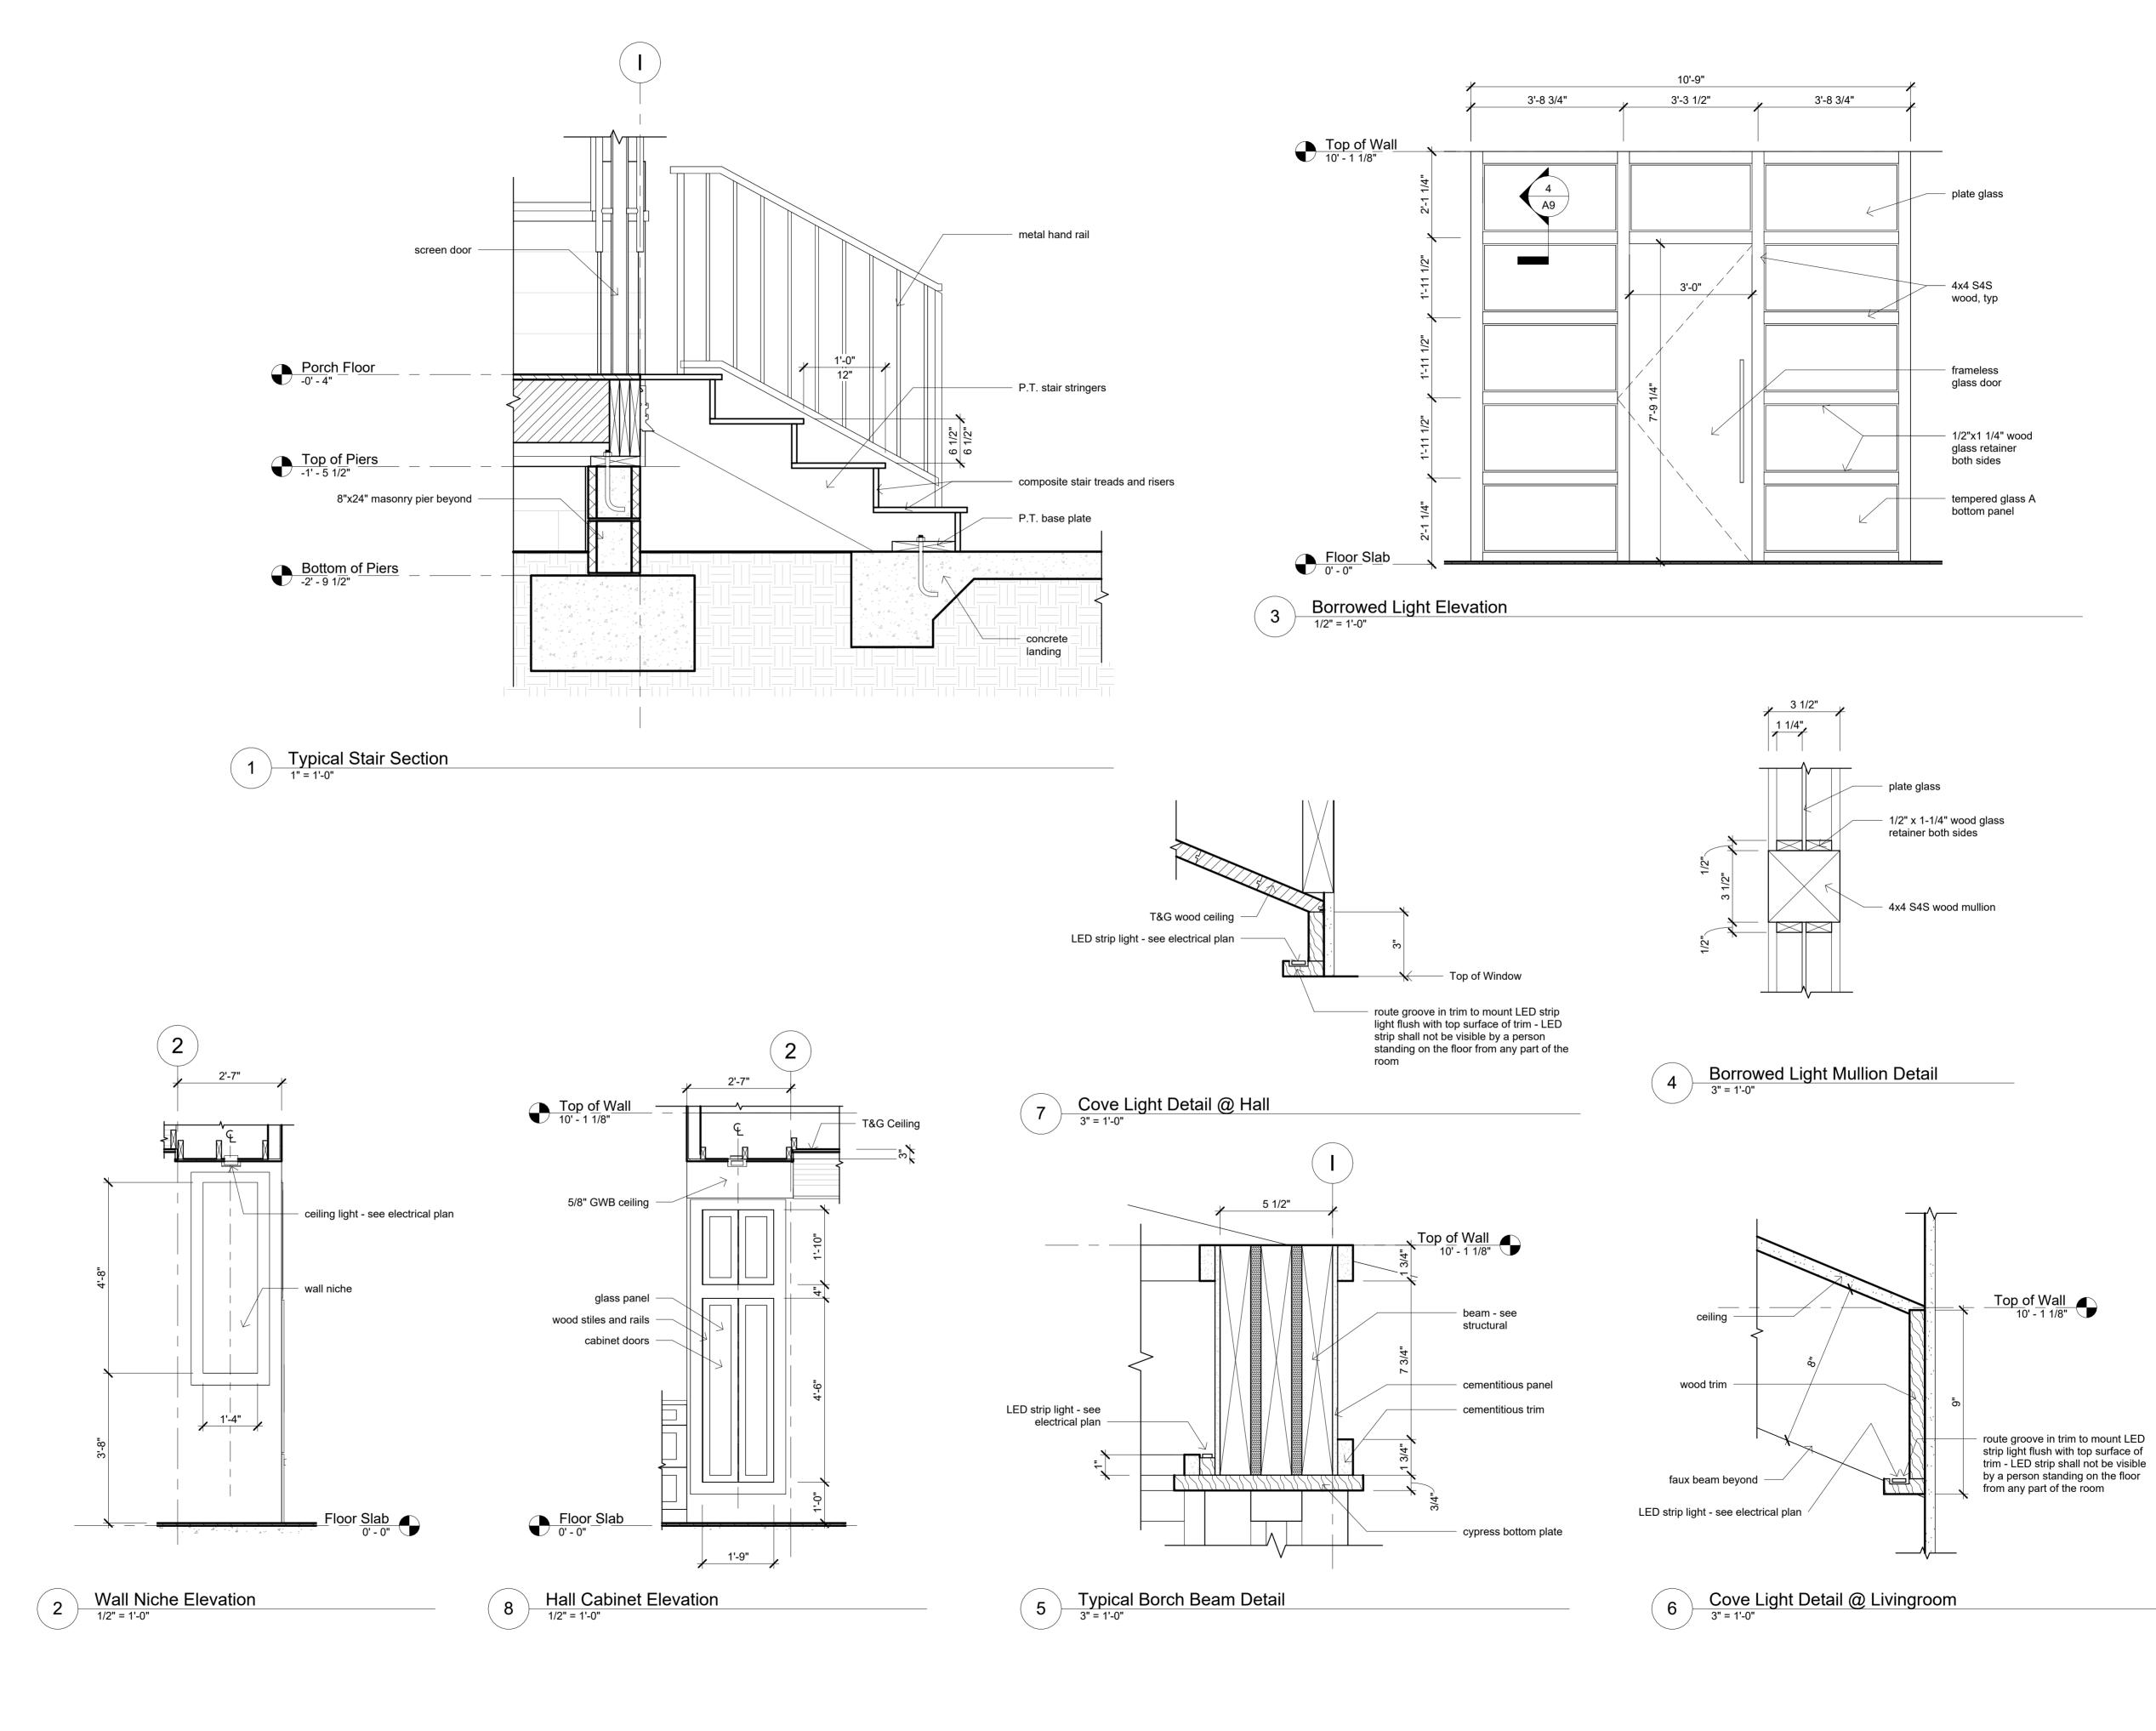

Home Sto Revision Date Number Date Date: 12/26/2024 Drawn: **Bob Harris** Description: Details SHEET **A9**

DESIGN

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